



# OPERATOR RESTROOM POINT RICHMOND BUS STOP

CASTRO ST. & TEWKSBURY AVE. RICHMOND, CA. PROJECT # P-2130

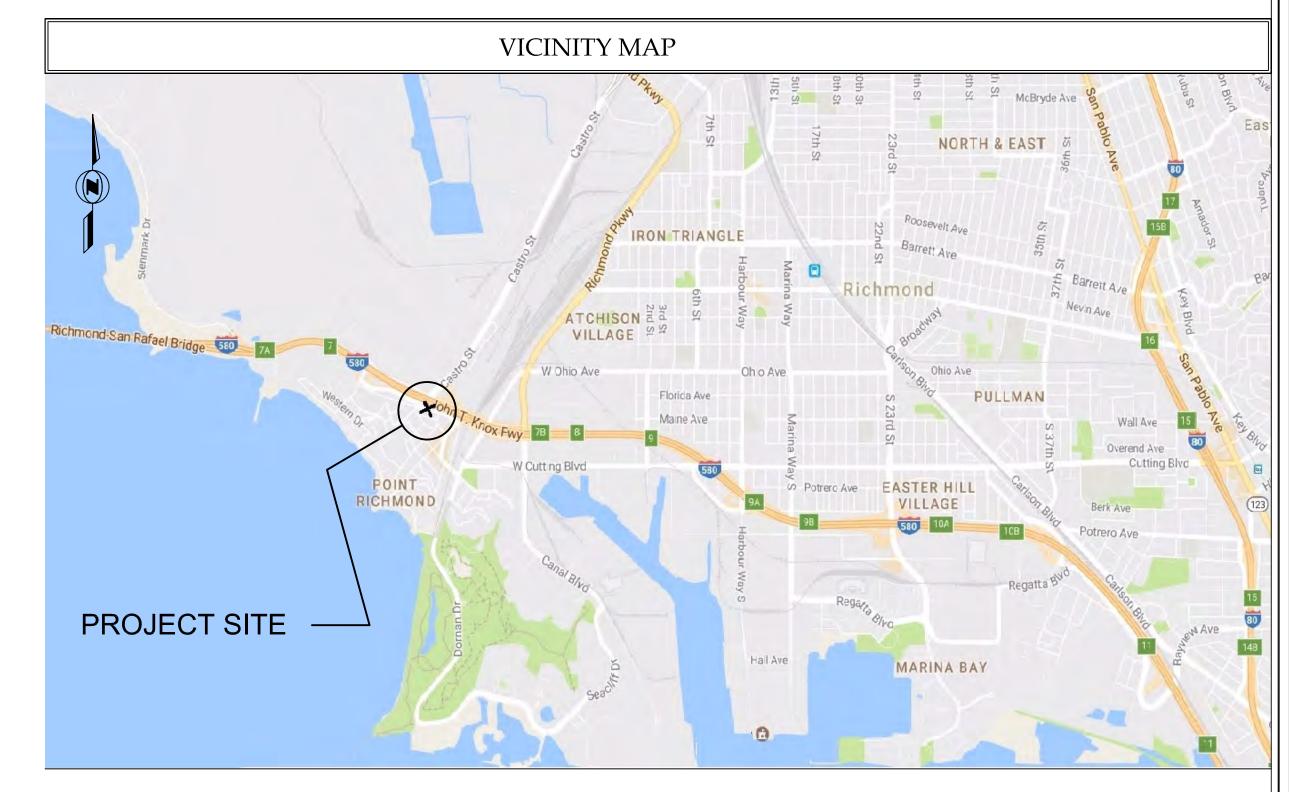

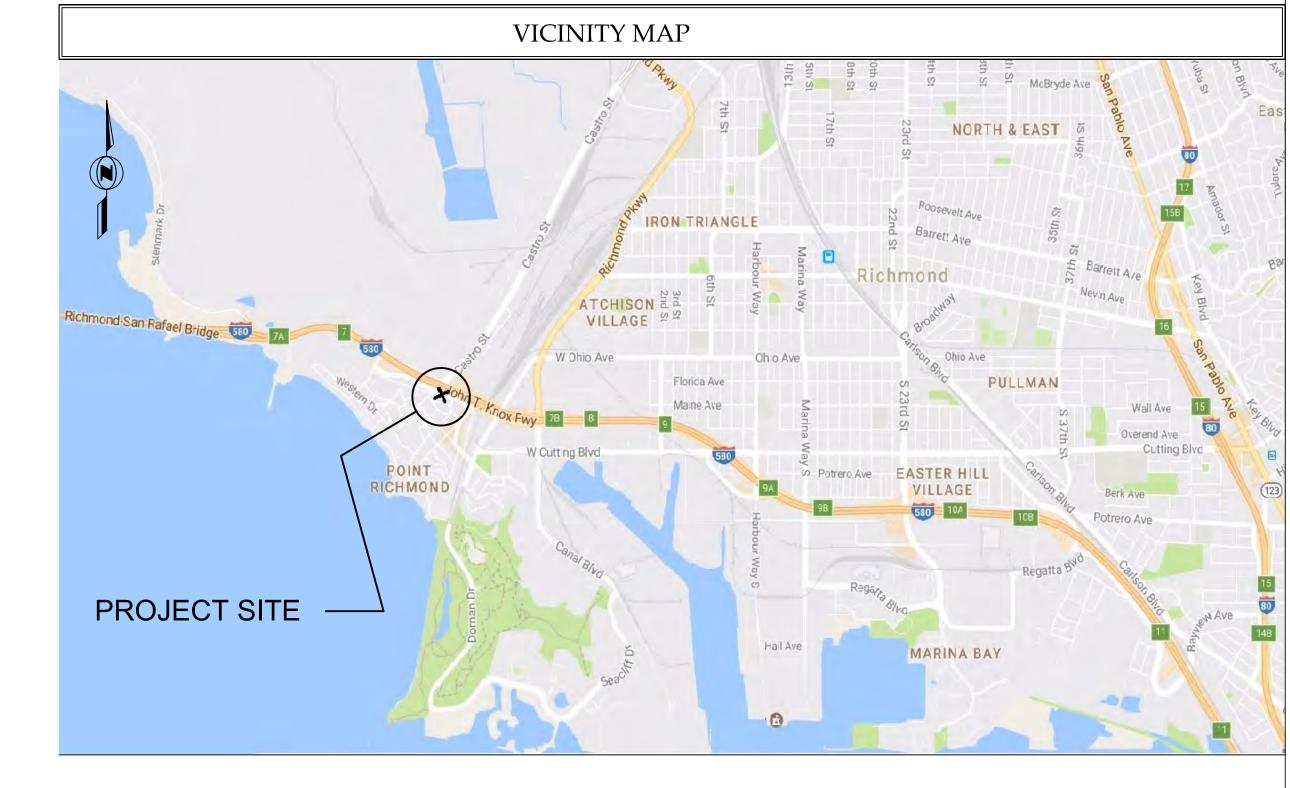



**ABBREVIATIONS** ON CENTER CONCRETE OPENING CONSTRUCTION JOINT OPPOSITE DRAIN INLET OUISIDE DIAMETER DIAMETER PORTLAND CEMENT CONCRETE DOWN PVMNT PAVEMENT DOMESTIC WATER **RADIUS** DRAWING REFERENCE RELATIVE COMPACTION EACH FACE SLOPE STORM DRAIN EQUAL STORM DRAIN CLEAN OUT (E), EXST EXISTING SANITARY SEWER STORMWATER **EXPANSION** SPECIFICATION FINISHED FLOOR STANDARD FINISHED GRADE STEEL FOOTING SYMMETRICAL FOUNDATION TOP OF CONCRETE TOP OF STEEL FLOW LINE TOP OF CURB GAS GAGE TRENCH DRAIN GRADE BREAK TOP OF GRATE HIGH DENSITY POLETHLENE TOP OF PAVEMENT HORIZONTAL TYPICAL TOTAL INDUSTRIAL WASTE UNLESS OTHERWISE NOTED JOINT UNDERGROUND STORAGE TANK LINEAR FEET LONG LONGITUDINAL WELDED WIRE MESH REINF.

APPLICABLE CODES

2016 CALIFORNIA BUILDING CODE

2016 CALIFORNIA PLUMBING CODE

2016 CALIFORNIA MECHANICAL CODE

2016 CALIFORNIA ELECTRICAL CODE

2016 CALIFORNIA ENERGY CODE

2016 CALIFORNIA GREEN BUILDING CODE

SITE INFORMATION

SITE NAME: POINT RICHMOND BUS STOP

SITE ADDRESS: TEWKSBURY AVENUE & CASTRO STREET POINT RICHMOND, CA

675 SQ. FT. AREA:

BENCH MARK

ELEVATIONS SHOWN HEREON ARE BASED UPON SMARTNET NORTH AMERICA CORS "CADY", ELEVATION 95.64 FEET (NAVD 88).

BASIS OF BEARINGS

THE STATE PLANE COORDINATE SYSTEM OF 1983 (NAD 83), CALIFORNIA ZONE 3.



CONTACT USA NORTH 811, UNDERGROUND SERVICE ALERT 48 HOURS BEFORE YOU DIG

811 or 800-642-2444 www.usanorth811.org

**IMPORTANT NOTICE** 

SECTION 4216/4217 OF THE GOVERNMENT CODE REQUIRES A DIGALERT IDENTIFICATION NUMBER BE ISSUED BEFORE A "PERMIT TO EXCAVATE" WILL BE VALID. FOR YOUR DIGALERT I.D. NUMBER CALL UNDERGROUND SERVICE ALERT TOLL FREE 1-800-642-2444 TWO WORKING DAYS BEFORE YOU DIG

DRAWING INDEX

SHEET DWG NO. SHEET TITLE

1 CO-TITLE SHEET

2 C1-GENERAL NOTES

3 C2-EXISTING CONDITIONS SURVEY

4 C3-DEMOLITION PLAN

5 C4-SITE PLAN

6 C5-UTILITY PLAN

7 C6-BLDG. FOUNDATION PLAN & DETAILS

8 C7-BLDG. FLOOR PLAN & SCHEDULES

9 SD1-STANDARD UTILITY DETAILS

SCOPE OF PROJECT

THESE PLANS ARE FOR SITE IMPROVEMENTS AND PROVISION AND INSTALLATION OF A PREMANUFACTURED RESTROOM BUILDING AS MANUFACTURED BY THE PUBLIC RESTROOM COMPANY (OR APPROVED EQUAL), INCLUDING ALL PERMITS, NEW UTILITIES AND ALL NEW TRENCHES, PULL BOXES AND SERVICE CONNECTIONS, INCLUDING SEWER, WATER, ELECTRICAL AND TWO EACH, COMMUNICATION MICROFIBER LINES, CONCRETE FOUNDATIONS, SIDEWALK AND FLATWORK AND STRUCTURAL CONCRETE AS SHOWN ON THE PLANS INCLUDING BUT NOT LIMITED TO BUILDING FOUNDATION AND A PAD FOR FUTURE BIKE LOCKERS (LOCKERS TO BE INSTALLED BY OTHERS).

**8** 5

4-5-19 AS NOTED SHEET SIZE ARCH D CHECKED JOB NO. 16R-120 DRAWING NO.

SHEET NO. 1 **of** 9 REVISION NO.

## GENERAL NOTES

- 1. ALL WORK SHALL BE IN COMPLIANCE WITH THE 2016 CALIFORNIA BUILDING CODE, 2016 CALIFORNIA FIRE CODE, 2016 CALIFORNIA MECHANICAL CODE, 2016 CALIFORNIA PLUMBING CODE, AND ALL APPLICABLE LOCAL, STATE, AND FEDERAL LAWS AND REGULATIONS.
- 2. THE CONTRACTOR SHALL ASSUME SOLE AND COMPLETE RESPONSIBILITY FOR JOB SITE CONDITIONS, INCLUDING SAFETY OF ALL PERSONS AND PROPERTY, DURING THE COURSE OF CONSTRUCTION OF THIS PROJECT. THIS REQUIREMENT SHALL APPLY CONTINUOUSLY AND NOT BE LIMITED TO NORMAL WORKING HOURS.
- 3. PRIOR TO COMMENCING CONSTRUCTION, THE CONTRACTOR SHALL VERIFY EXISTING DIMENSIONS, ELEVATIONS, AND CONDITIONS. INCLUDING CONDITIONS FOR GRADING, DRAINAGE AND UNDERGROUND FACILITIES. IF CONDITIONS DIFFER FROM THOSE SHOWN ON THE PLANS, THE CONTRACTOR SHALL NOTIFY THE ENGINEER AND SHALL NOT BEGIN CONSTRUCTION UNTIL THE CHANGED CONDITIONS HAVE BEEN EVALUATED.
- 4. THE CONTRACTOR SHALL BE RESPONSIBLE FOR REVIEW AND COORDINATION OF ALL PROJECT DOCUMENTS, DRAWINGS, AND SPECIFICATIONS PRIOR TO THE START OF CONSTRUCTION. ANY DISCREPANCIES, OMISSIONS, AND/OR CONFLICTS WITH CODE REQUIREMENTS SHALL BE REPORTED TO THE OWNER'S REPRESENTATIVE PRIOR TO THE START OF CONSTRUCTION SO THAT A CLARIFICATION CAN BE ISSUED. ANY WORK PERFORMED IN CONFLICT WITH THE CONTRACT DOCUMENTS OR IN CONFLICT WITH ANY CODE REQUIREMENTS SHALL BE CORRECTED BY THE CONTRACTOR AT THEIR OWN EXPENSE AND AT NO EXPENSE TO THE OWNER OR ENGINEER.
- 5. THE CONTRACTOR SHALL DEFEND, INDEMNIFY AND HOLD THE ENGINEER HARMLESS FROM ANY AND ALL LIABILITY, REAL OR ALLEGED, IN CONNECTION WITH THE PERFORMANCE OF WORK ON THIS PROJECT, EXCEPTING LIABILITY ARISING FROM THE SOLE NEGLIGENCE OF THE ENGINEER.
- 6. ANY DEVIATION, SUBSTITUTION OR ALTERATION TO THE DESIGN SHALL BE SUBJECT TO REVIEW BY THE ENGINEER.
- 7. THE EXISTENCE, LOCATION AND CHARACTERISTICS OF UTILITY INFORMATION SHOWN HAS BEEN OBTAINED FROM A REVIEW OF AVAILABLE RECORDS DATA. NO REPRESENTATION IS MADE AS TO THE ACCURACY OR COMPLETENESS OF SAID UTILITY INFORMATION. THE CONSTRACTOR SHALL TAKE PRECAUTIONARY MEASURES TO PROTECT THE UTILITY LINES WHETHER SHOWN OR NOT ON THESE PLANS.
- 8. THE CONTRACTOR SHALL REPAIR OR REPLACE ANY DAMAGE TO EXISTING FACILITIES OCCURING DURING THE COURSE OF DEMOLITION, EXCAVATION, OR CONSTRUCTION, WHETHER RESULTING DIRECTLY OR INDIRECTLY FROM THEIR OPERATIONS, WHETHER OR NOT SHOWN ON THESE DRAWINGS, WITHOUT ADDITIONAL COST TO THE OWNER.
- 9. DRAWINGS INDICATE GENERAL AND TYPICAL DETAILS OF CONSTRUCTION. WHERE CONDITIONS ARE NOT SPECIFICALLY INDICATED BUT ARE OF SIMILAR CHARACTER TO DETAILS SHOWN, SIMILAR DETAILS OF CONSTRUCTION SHALL BE APPLIED, SUBJECT TO REVIEW BY THE ENGINEER.
- 11. THE CONTRACTOR SHALL OBTAIN ALL REQUIRED PERMITS, THE CONTRACTOR SHALL PAY FOR ALL OF THE WORK TO OBTAIN AND TO COMPLY WITH ALL PERMIT REQUIREMENTS. THE DISTRICT WILL REIMBURSE THE CONTRACTOR FOR THE PERMIT FEES ONLY.
- 12. THE CONTRACTOR SHALL SUBMIT "AS-BUILT" DRAWINGS TO THE OWNER (AC TRANSIT) UPON COMPLETION OF WORK. RETENTIONS SHALL NOT BE RELEASED PRIOR TO THE CONTRACTOR'S SUBMITTAL OF APPROVED "AS-BUILTS".
- 13. THE CONTRACTOR SHALL BE RESPONSIBLE FOR THE PROTECTION OF THE TREE ON THE WEST SIDE OF THE RESTROOM STRUCTURE. EXCAVATIONS FOR CONCRETE FOOTINGS, SLABS, AND FOUNDATIONS SHALL BE HAND DUG IN THE VICINITY OF THE TREE. ROOTS THAT ARE EXPOSED SHALL BE EXPOSED AND PROTECTED IN PLACE AND THE ENGINEER NOTIFIED IF ANY ROOTS ARE IN CONFLICT WITH ANY ELEMENT OF THE PROJECT. TRENCHING FOR UTILITIES MAY NOT BE MADE WITHIN THE DRIPLINE OF THIS TREE.

## CONSTRUCTION

- 1. FIRE EXTINGUISHER: CONTRACTOR SHALL PROVIDE AND MAINTAIN A PORTABLE FIRE EXTINGUISHER OF THE TYPE SIZE APPROVED BY THE FIRE DEPARTMENT FIELD INSPECTOR AT THE JOB SITE THROUGHOUT CONSTRUCTION.
- 2. NO HAZARDOUS MATERIALS: NO HAZARDOUS CHEMICALS OR MATERIALS SHALL BE USED OR STORED IN THIS AREA OR ADJACENT AREAS TO THIS PROJECT.
- 3. COMPLY W/DRAWINGS: IT SHALL BE THE RESPONSIBILITY OF THE CONTRACTOR TO COORDINATE, SUPERVISE, AND COMMUNICATE WITH THE ENGINEER, OWNER, AND SUBCONTRACTORS ALL WORK TO INSURE CONFORMANCE WITH THE APPROVED DRAWINGS AND SPECIFICATIONS.
- 4. HOT WORK: PRIOR WRITTEN APPROVAL AND HOT WORK PERMIT FOR ALL FIELD WELDING IS REQUIRED.
- 5. RIGGING: ALL RIGGING SHALL BE SCHEDULED, COORDINATED, AND HAVE PRIOR APPROVAL FROM OWNER (AC TRANSIT).
- 6. SITE CLEANLINESS: THE CONTRACTOR SHALL BE RESPONSIBLE FOR THE DAILY REMOVAL AND LEGAL DISPOSAL OF ALL DEMOLITION SPOILS AND REMOVED MATERIALS. THE CONTRACTOR MAY NOT STOCKPILE OR STORE ANY NEW OR REMOVED MATERIAL ON SITE.
- 7. COMPACTION (MIN): ALL FILL SOILS OR SOILS DISTURBED OR OVEREXCAVATED SHALL BE COMPACTED TO NOT LESS THAN 95% PERCENT OF MAXIMUM DENSITY AS DETERMINED BY A.S.T.M. SOIL COMPACTION TEST D1557. ALL BACKFILL SHALL BE 100% VIRGIN CLASS 2 AB COMPACTED TO 95% IN ACCORDANCE WITH THE ASTM D1557.
- 8. FIELD DENSITY: SHALL BE DETERMINED BY NUCLEAR GAUGE OR DRIVE CYLINDER METHOD. IN FINE—GRAINED COHESIVE SOILS, FIELD DENSITY MAY BE DETERMINED BY THE DRIVE—CYLINDER METHOD, A.S.T.M. D2937—71, THE METHOD OF DETERMINING FIELD DENSITY SHALL BE SHOWN IN THE COMPACTION REPORT. OTHER METHODS MAY BE USED IF RECOMMENDED BY THE SOIL ENGINEER AND APPROVED IN ADVANCE BY BUILDING OFFICIAL.
- 9. SAWCUT REMOVALS: ALL PAVEMENT AND CONCRETE REMOVALS SHALL BE SAWCUT.
- 10. ADJUST (E) TO (F.G.): EXISTING SLABS, CURBS, GUTTERS AND ASPHALT & CONCRETE PAVEMENT WITHIN THE LIMITS OF NEW CONSTRUCTION SHALL BE ADJUSTED TO FINAL GRADE, UNLESS INDICATED OTHERWISE.
- 11. CONCRETE CURBS, GUTTERS AND SIDEWALKS SHALL BE CONSTRUCTED IN ACCORDANCE WITH SECTION 303-5.4 OF THE "STANDARD SPECIFICATIONS FOR PUBLIC WORKS CONSTRUCTION" UNLESS INDICATED OTHERWISE.
- 12. CONSTRUCTION DUST CONTROL: MEASURES SHALL BE REQUIRED IN ACCORDANCE WITH CITY'S DUST CONTROL ORDINANCE. GRADING WILL BE DISCONTINUED DURING FIRST—STAGE SMOG, DURING CONSTRUCTION, DUST CONTROL ALERTS AND SUSPENDED DURING PERIODS OF HIGH WIND, I.E. OVER 15 MPH ALL HAULING TRUCKS SHALL HAVE LOADS COVERED OR WETTED AND LOADED BELOW THE SIDEBOARD LEVEL TO MINIMIZE DUST.

# MATERIAL REQUIREMENTS:

#### BACK FILL:

A. AGGREGATE BASE:

\*95% RELATIVE COMPACTION, PLACEMENT IN 8" LIFTS

\*90% PASSING NO. 4 SIEVE AND LESS THAN 5% PASSING NO. 200 SIEVE. B. LEAN CONCRETE MIX:

- \* MIN OF 188 LBS OF PORTLAND CEMENT PER CY
- \* WATER CONTENT SUFFICIENT TO PRODUCE A FLUID, WORKABLE MIX THAT WILL FLOW AND CAN BE PUMPED WITHOUT SEGREGATION OF THE AGGREGATE DURING PLACEMENT.

AGGREGATE BASE: 100 % VIRGIN CLASS II AGGREGATE BASE 95% MIN COMPACTION

WELDING: AWS D1.1 SPECIFICATIONS. E-70XX ELECTRODES

REINFORCING BARS: ASTM A615 OR A615M GRADE 60, DEFORMED

#### CONCRETE:

READY MIX OR PROJECT—SITE MIXING: ASTM C 94.

PORTLAND CEMENT: ASTM C 150, TYPE 1 OR II.

MIN 594 LBS OF PORTLAND CEMENT PER CY
28-DAY ULTIMATE COMPRESSIVE STRENGTH OF 3500 PSI

AGGREGATE: ASTM C 33, UNIFORM GRADATION,  $\frac{3}{4}$ " MAXIMUM AGGREGATE. WATER: ASTM C 94

CURING COMPOUND: ASTM C 309


ADMIXTURES: ASTM C 494

# **EXECUTION**

- 1. SAW CUT AND DEMO SLAB. EXCAVATE SOIL TO DEPTH SHOWN ON THE PLANS. SCARIFY SUBBASE AND COMPACT TO 95%.
- 2. BACKFILL AS NECESSARY WITH AGGREGATE BASE. PLACE BASE AND COMPACT TO 95%. FORM AND POUR FOOTING FOR PREMANUFADCTURED BUILDING. PROVIDE LEVELING SAND BASE BELOW THE BUILDING FOUNDATION SLAB. STOCKPILE EXTRA SAND FOR THE MANUFACTURER'S USE DURING INSTALLATION.
- 3. CONTRACTOR TO PREPARE SITE FOR CRANE AND RIGGING FOR LIFTING AND SETTING OF THE BUILDING. CONTRACTOR TO TRENCH AND INSTALL UTILITES FROM THE UTILITY SERVICE CONNECTION TO THE POC SHOWN ON THE UTILITY DRAWING (APPROXIMATELY 5 FOOT FROM THE BUILDING).
- 4. PLACE CONCRETE SIDEWALK AROUND THE RESTROOM BUILIDING AND SLAB FOR BIKE LOCKERS. CONCRETE PLACEMENT TO COMPLY WITH ACI 304R FOR MEASURING, MIXING, TRANSPORTING, AND PLACING CONCRETE.
  - CONSOLIDATE CONCRETE WITH MECHANICAL VIBRATING EQUIPMENT.
  - SCREED AND INITIAL FLOAT CONCRETE SURFACES USING BULL FLOATS OR DARBIES BEFORE EXCESS MOISTURE OR BLEED WATER APPEARS ON THE SURFACE.
- 5. CURING CONCRETE:
- BEGIN CURING AFTER FINISHING CONCRETE, BUT NOT BEFORE FREE WATER HAS DISAPPEARED FROM THE CONCRETE SURFACE.
- CURE FOR AT LEAST 7 DAYS BY CONTINUOUS MOIST CURING, MOISTURE RETAINING—COVER CURING, OR CURING COMPOUND.
- CURING COMPOUND SHALL BE PROTECTED FROM DAMAGE FOR THE FULL 7 DAY CURE TIME.
- HI-EARLY STRENGTH CONCRETE SHALL BE CURED FOR AT LEAST 3 DAYS.

## PREMANUFACTURED BUILDING:

- 1. CONTRACTOR IS TO FURNISH AND INSTALL THE PRENGINEERED AND PREMANUFACTERED RESTROOM BUILDING AS SHOWN IN THESE PLANS AND PER THE PROJECT SPECIFICATIONS. THE CONTRACTOR SHALL PROVIDE ARCHITECTURAL AND STRUCTURAL DRAWINGS AND CALCULATIONS STAMPED BY A ARCHITECT OR CIVIL OR STRUCTURAL ENGINEER REGISTERED IN THE STATE OF CALIFORNIA.
- 2. THE CONTRACTOR IS COMPLETELY RESPONSIBLE FOR PROVIDING THE PRE-MANUFACTURED RESTROOM STRUCTURE INCLUDING ALL ELEMENTS, DETAILS, APPURTENANCES, INCLUDING THE PREPARATON AND SUBMITTAL OF A COMPLETE DEFERRED SUBMITTAL TO THE CITY OF RICHMOND FOR THE PRE-MANUFACTURED RESTROOM STRUCTURE INCLUDING ALL ELEMENTS, UTILITIES, DETAILS AND APPURTENANCES. THE CONTRACTOR SHALL BE RESPONSIBLE FOR OBTAINING APPROVAL PRIOR TO THE INSTALLATION OF THE STRUCTURE.

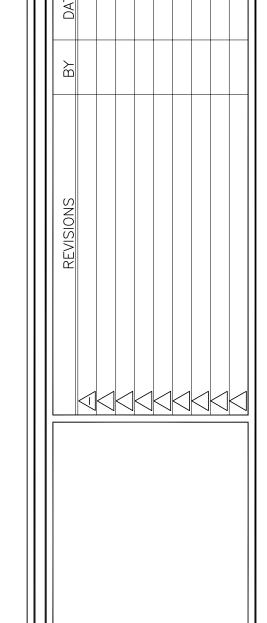

PARDEE LANE, SUITE 100

OAKLAND, CA 94621

AVE. CHOV
7770

S7. Phone: (51
Web: www.chow

& TEWKSBURY AVE AC TRANSIT T 1600 FRANKLIN ST.

FENERAL NOTES
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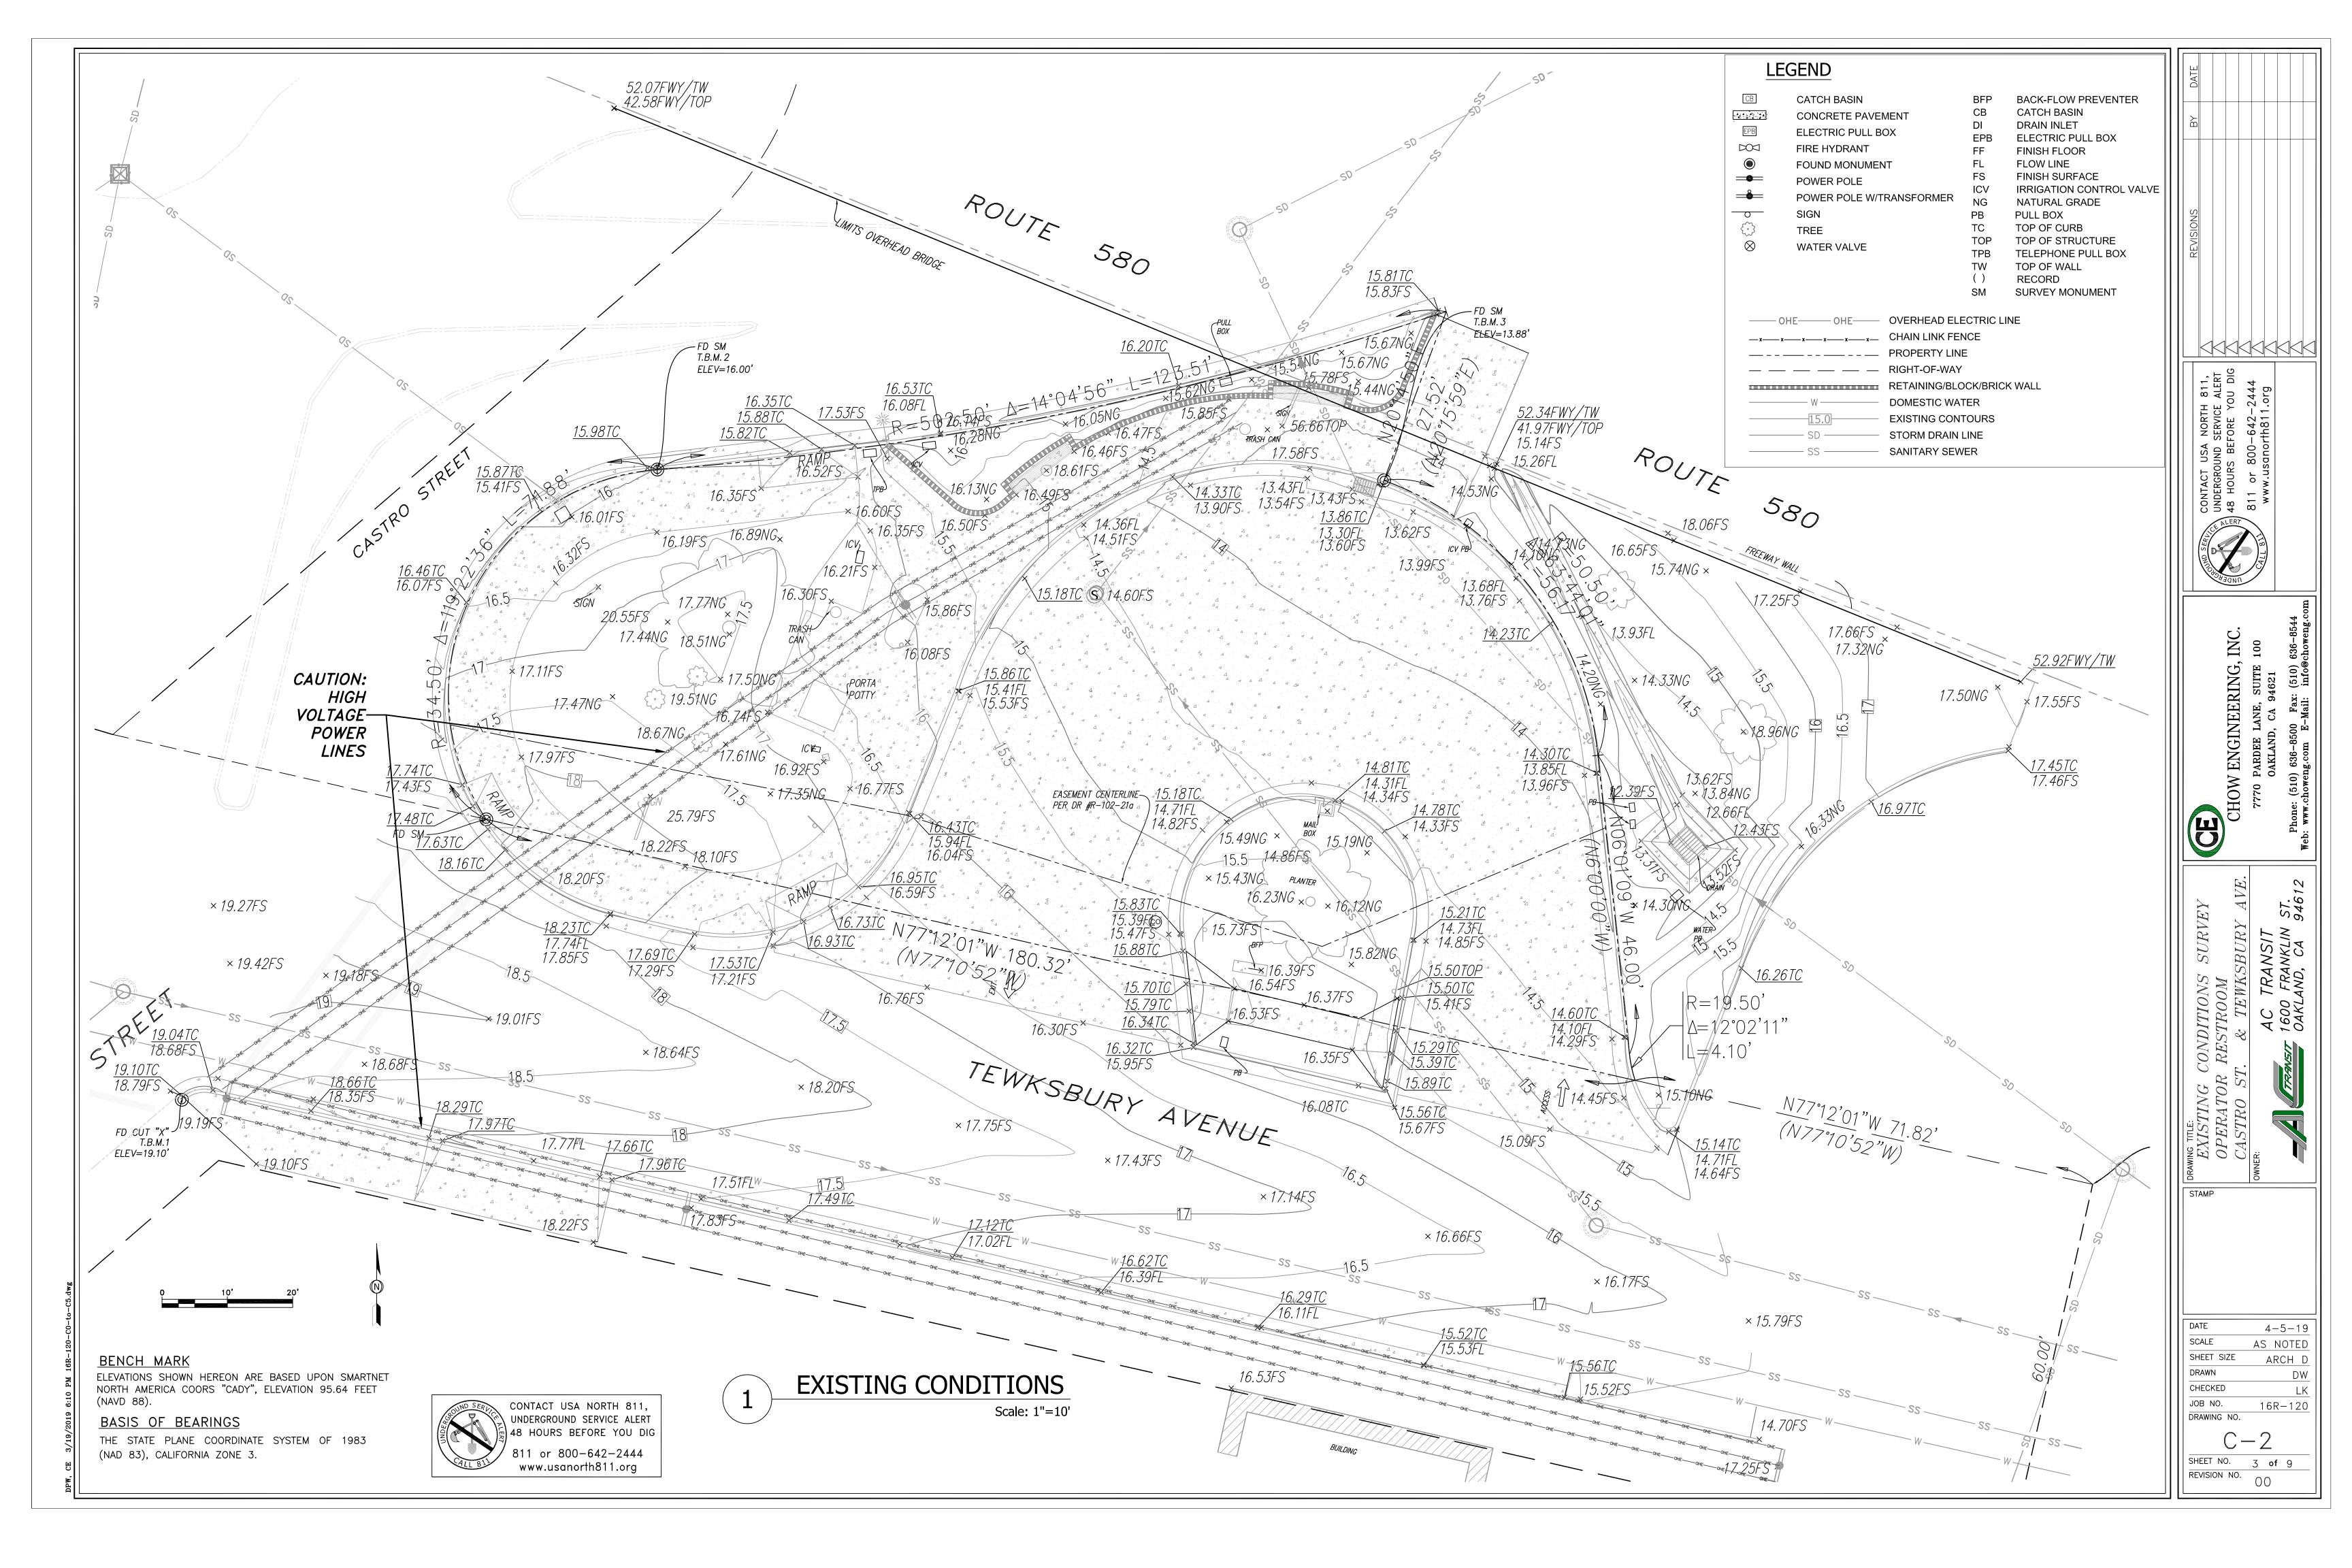
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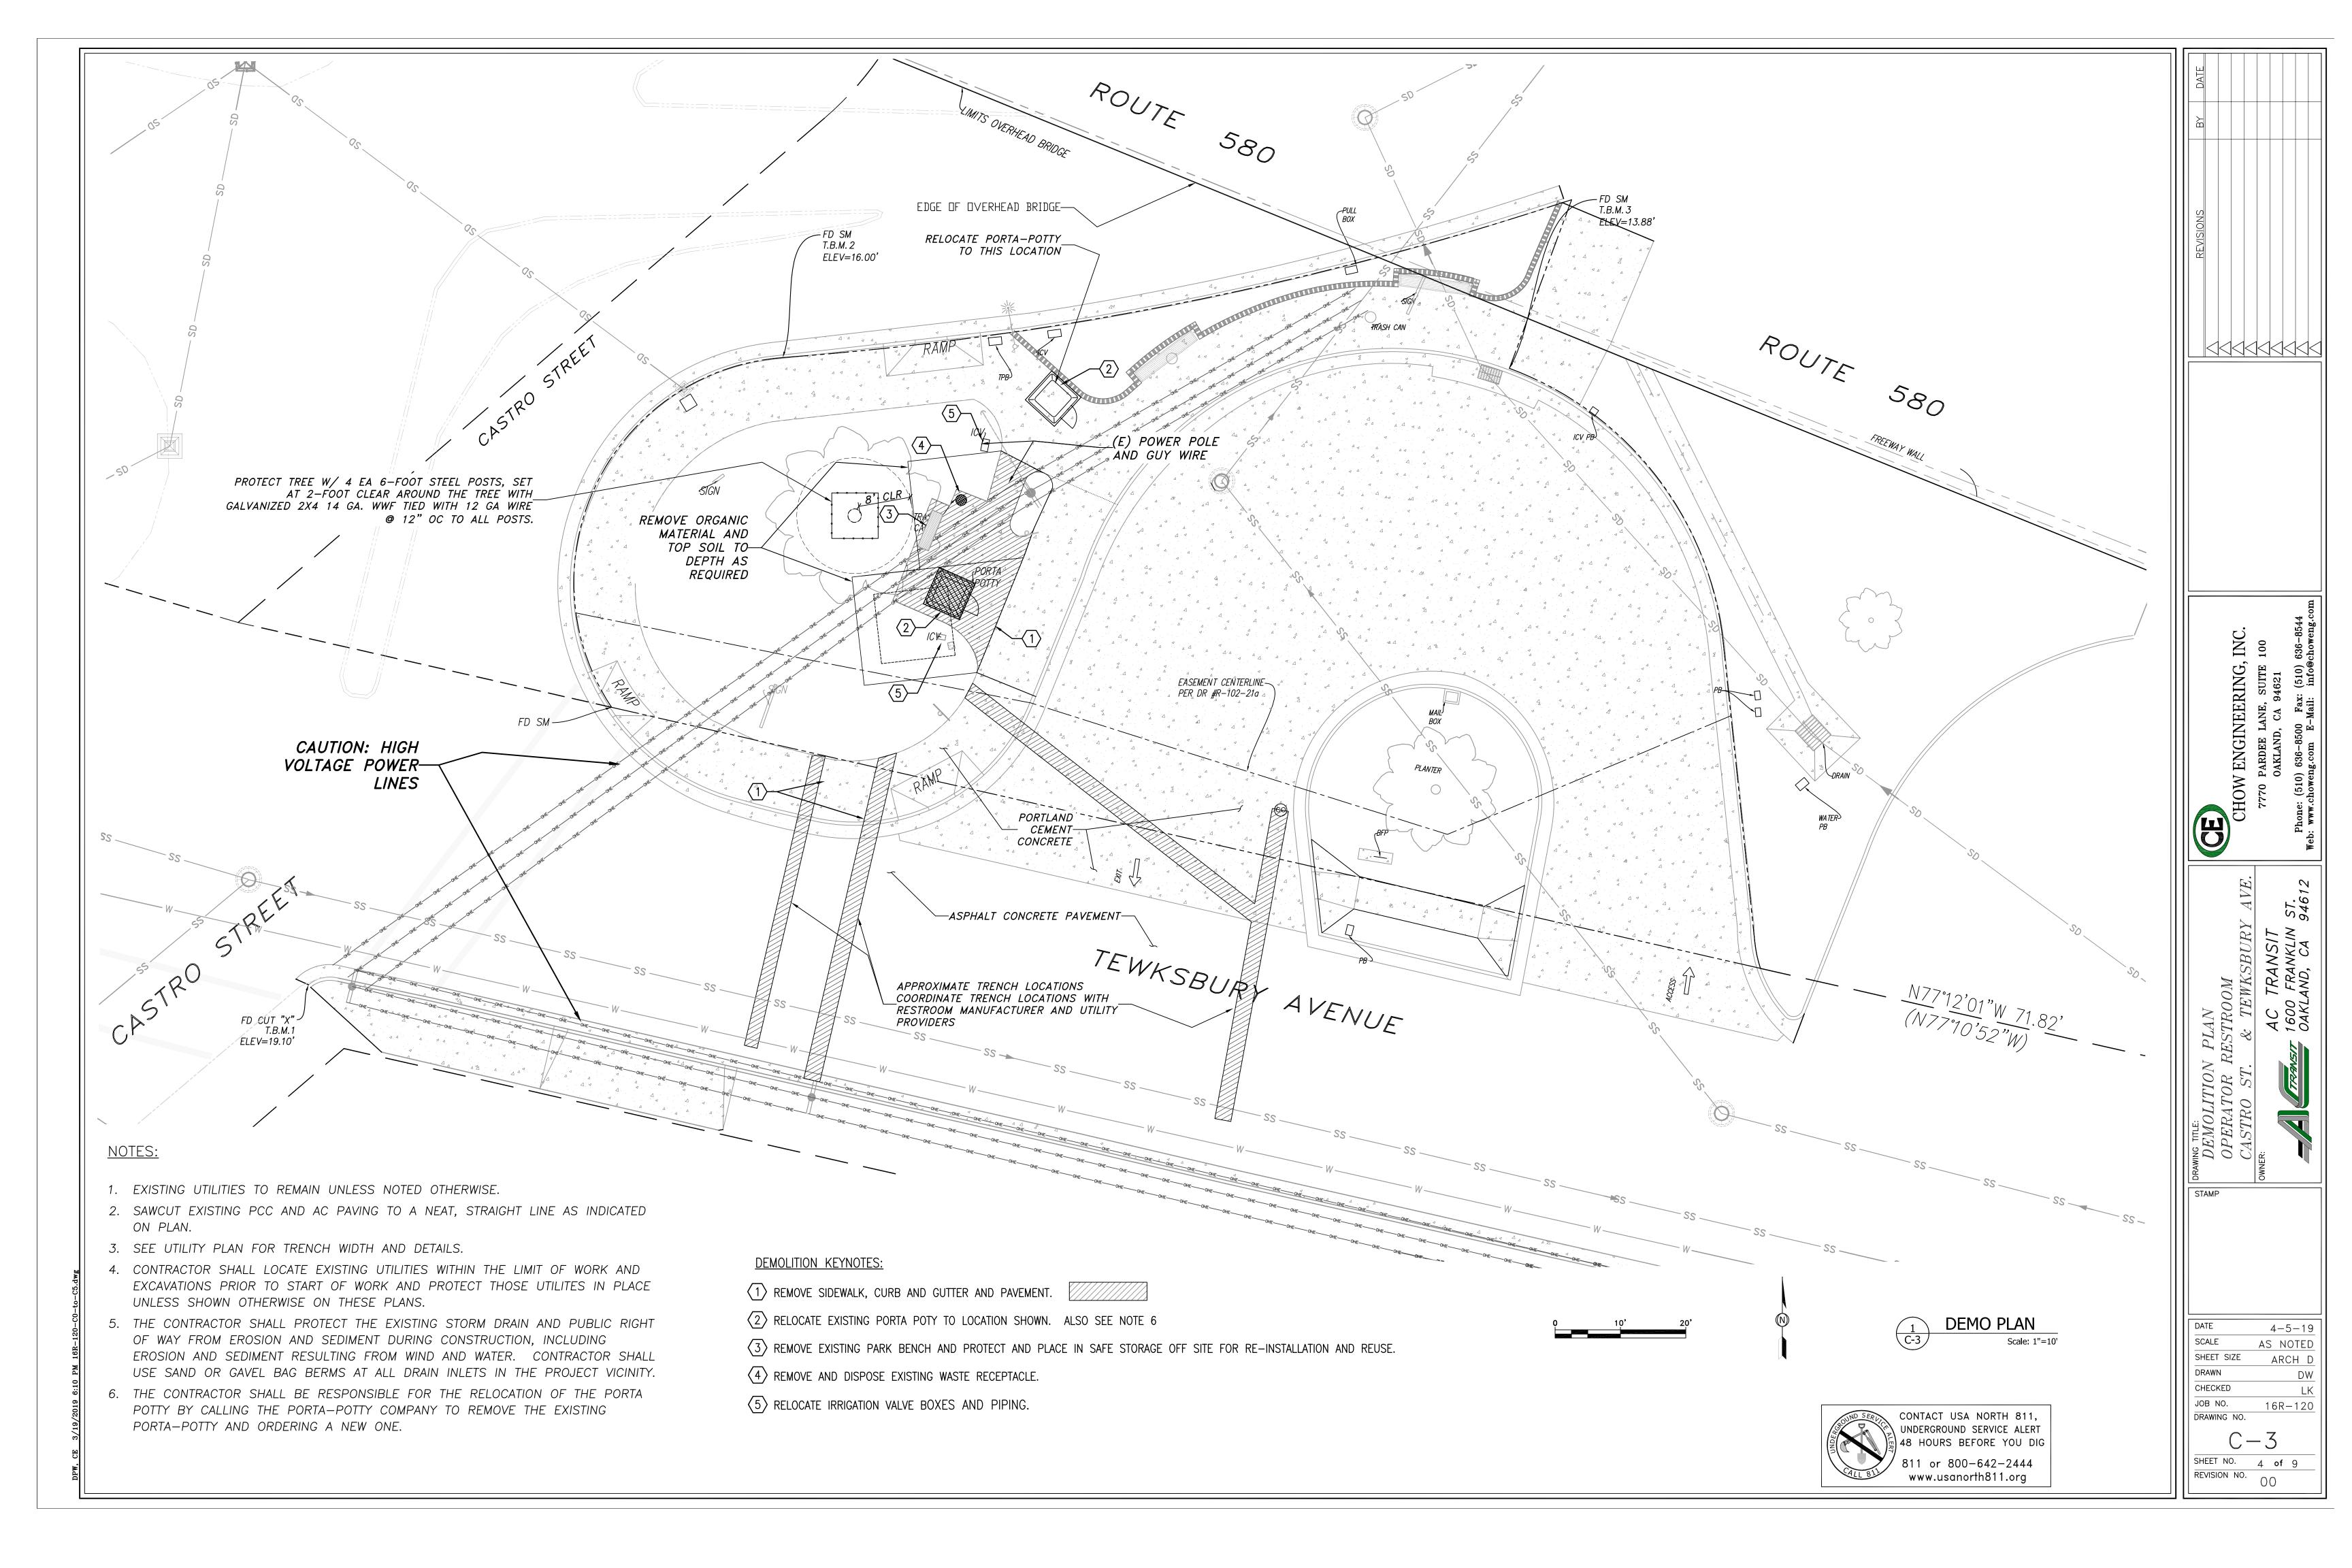
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REVISION NO.


## SPECIAL INSPECTIONS


- 1. ANY INSPECTIONS, SPECIAL OR OTHERWISE, THAT ARE REQUIRED BY THE BUILDING CODES, LOCAL BUILDING DEPARTMENTS, OR THESE PLANS, SHALL BE DONE BY AN INDEPENDENT INSPECTION COMPANY. JOB SITE VISITS BY THE ENGINEER DO NOT CONSTITUTE, OR SUBSTITUTE, INSPECTIONS UNLESS SPECIFICALLY CONTRACTED FOR.
- 2. THE CONTRACTOR SHALL BE RESPONSIBLE TO COMPLY WITH ALL SPECIAL INSPECTIONS REQUIRED BY THE STATE AND LOCAL AGENCIES AS STATED IN THE 2016 CBC SECTION 1704.


CONTACT USA NORTH 811, UNDERGROUND SERVICE ALERT 48 HOURS BEFORE YOU DIG 811 or 800-642-2444 www.usanorth811.org







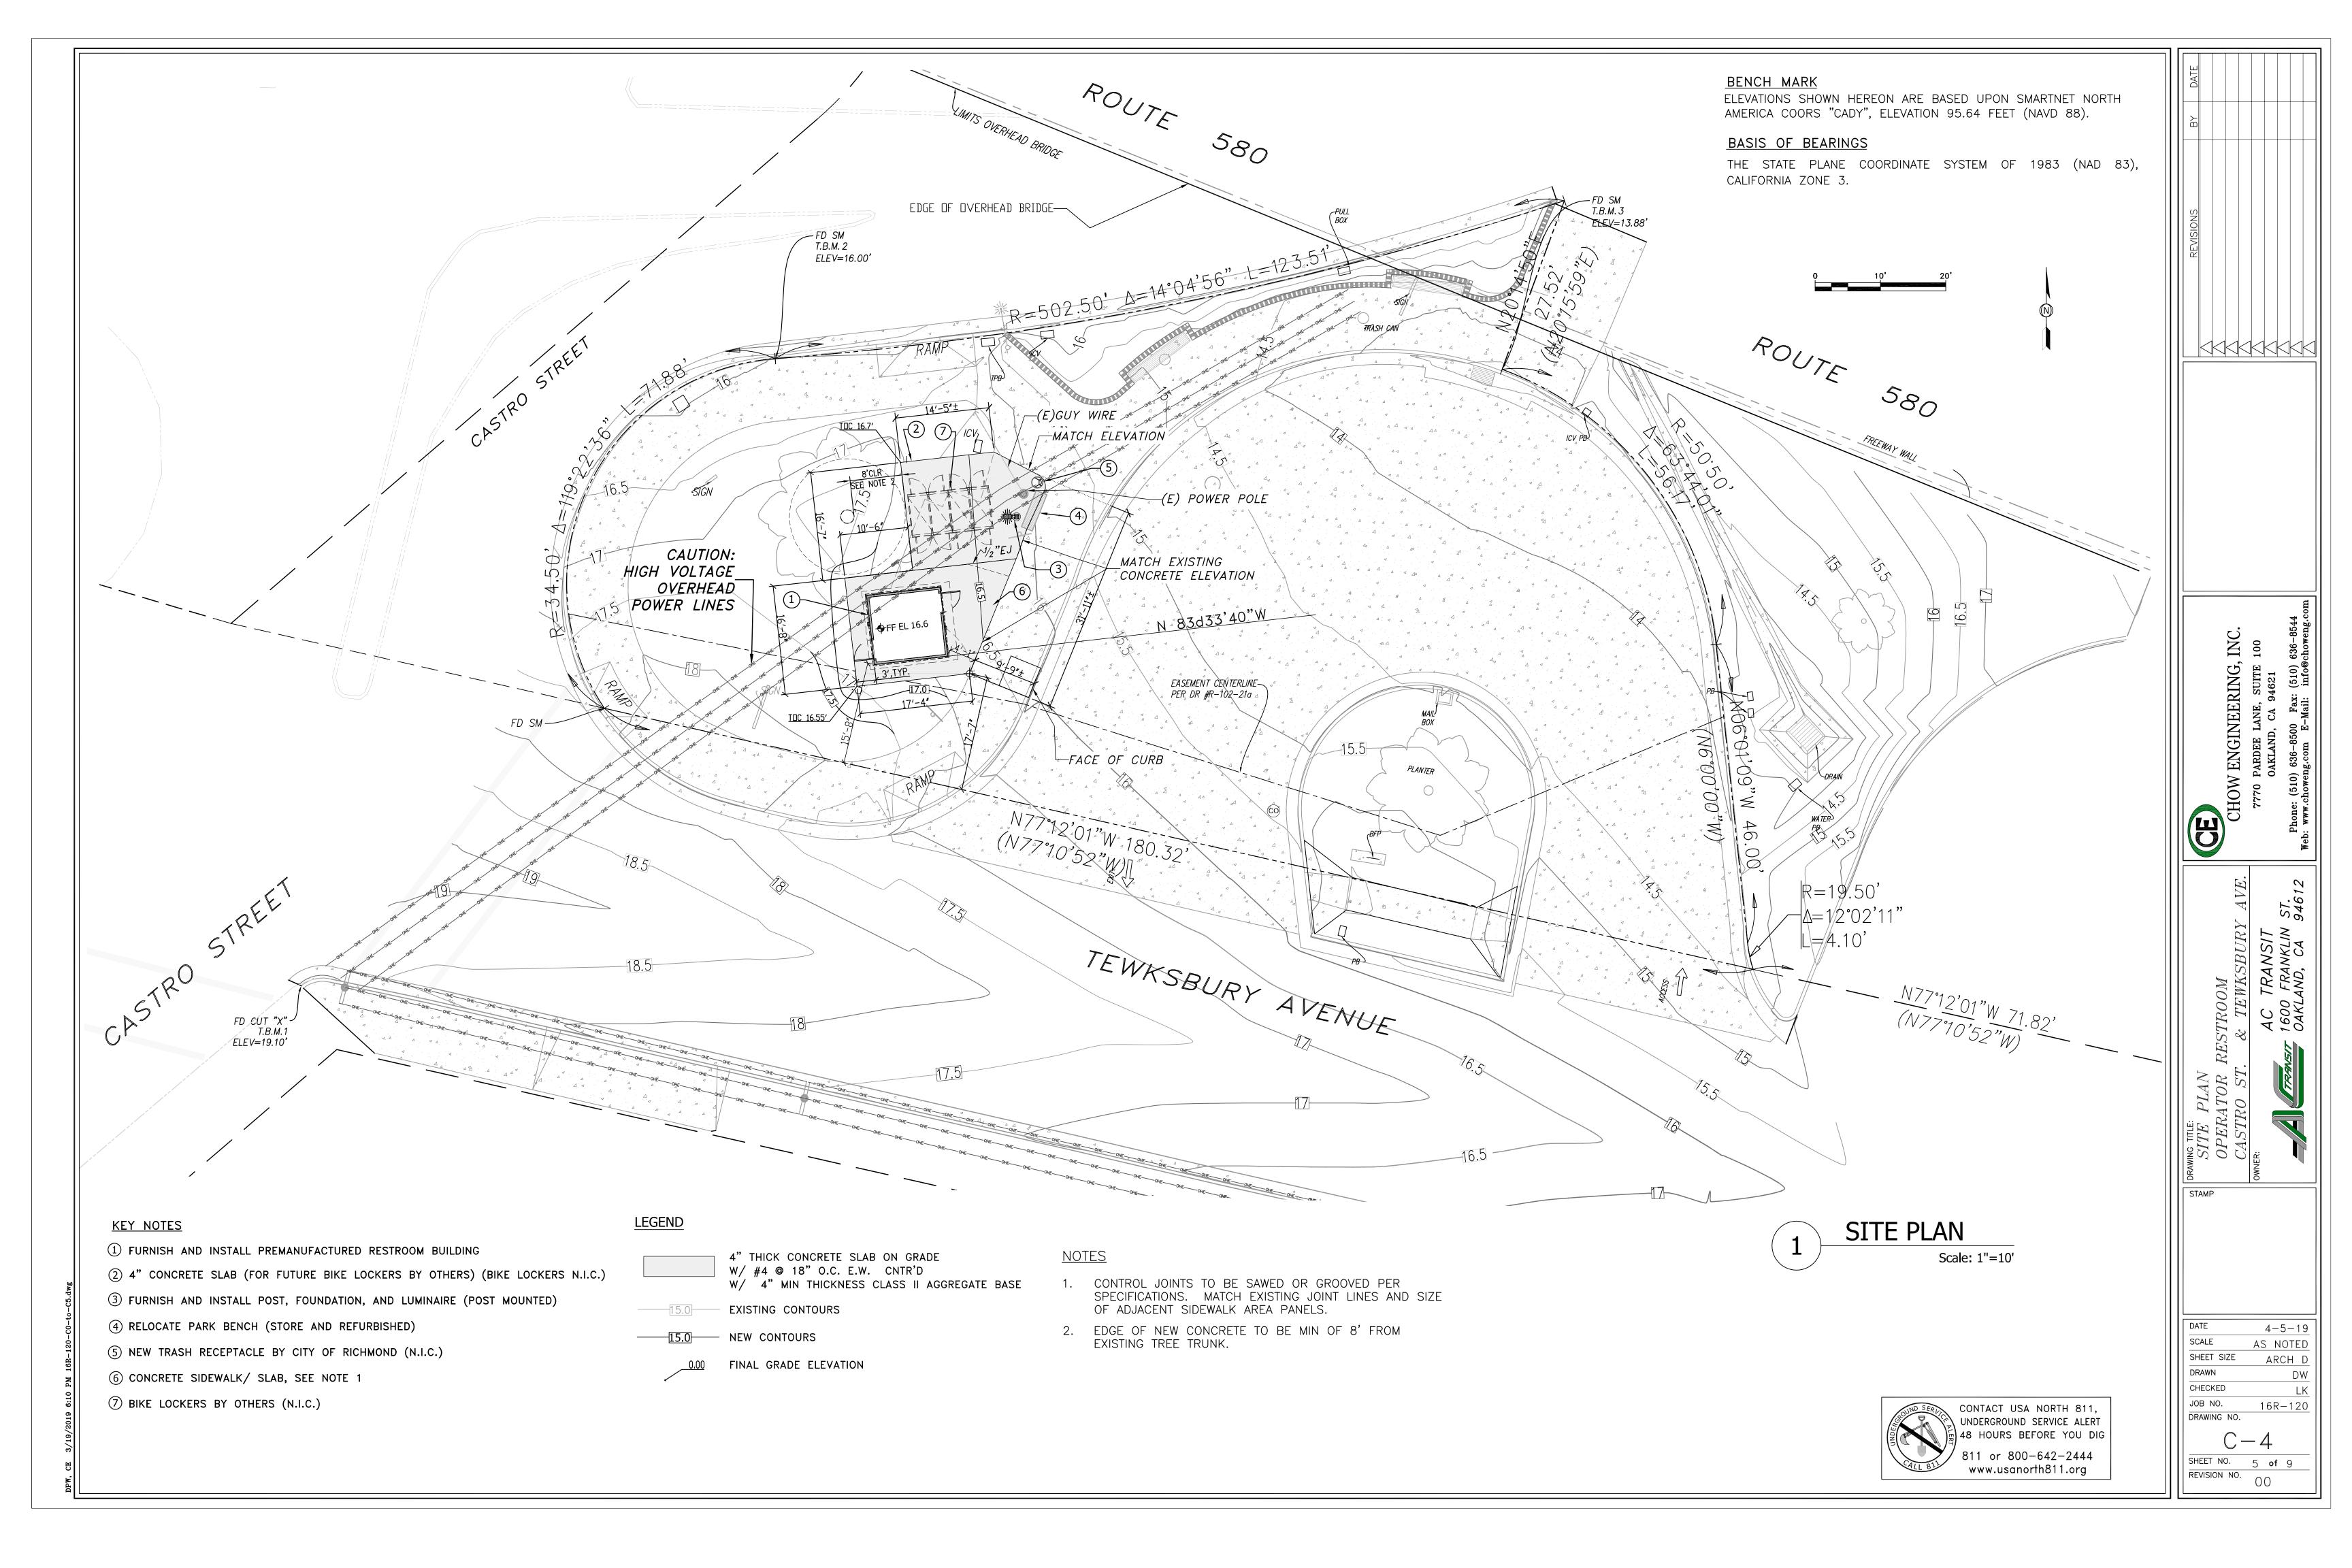

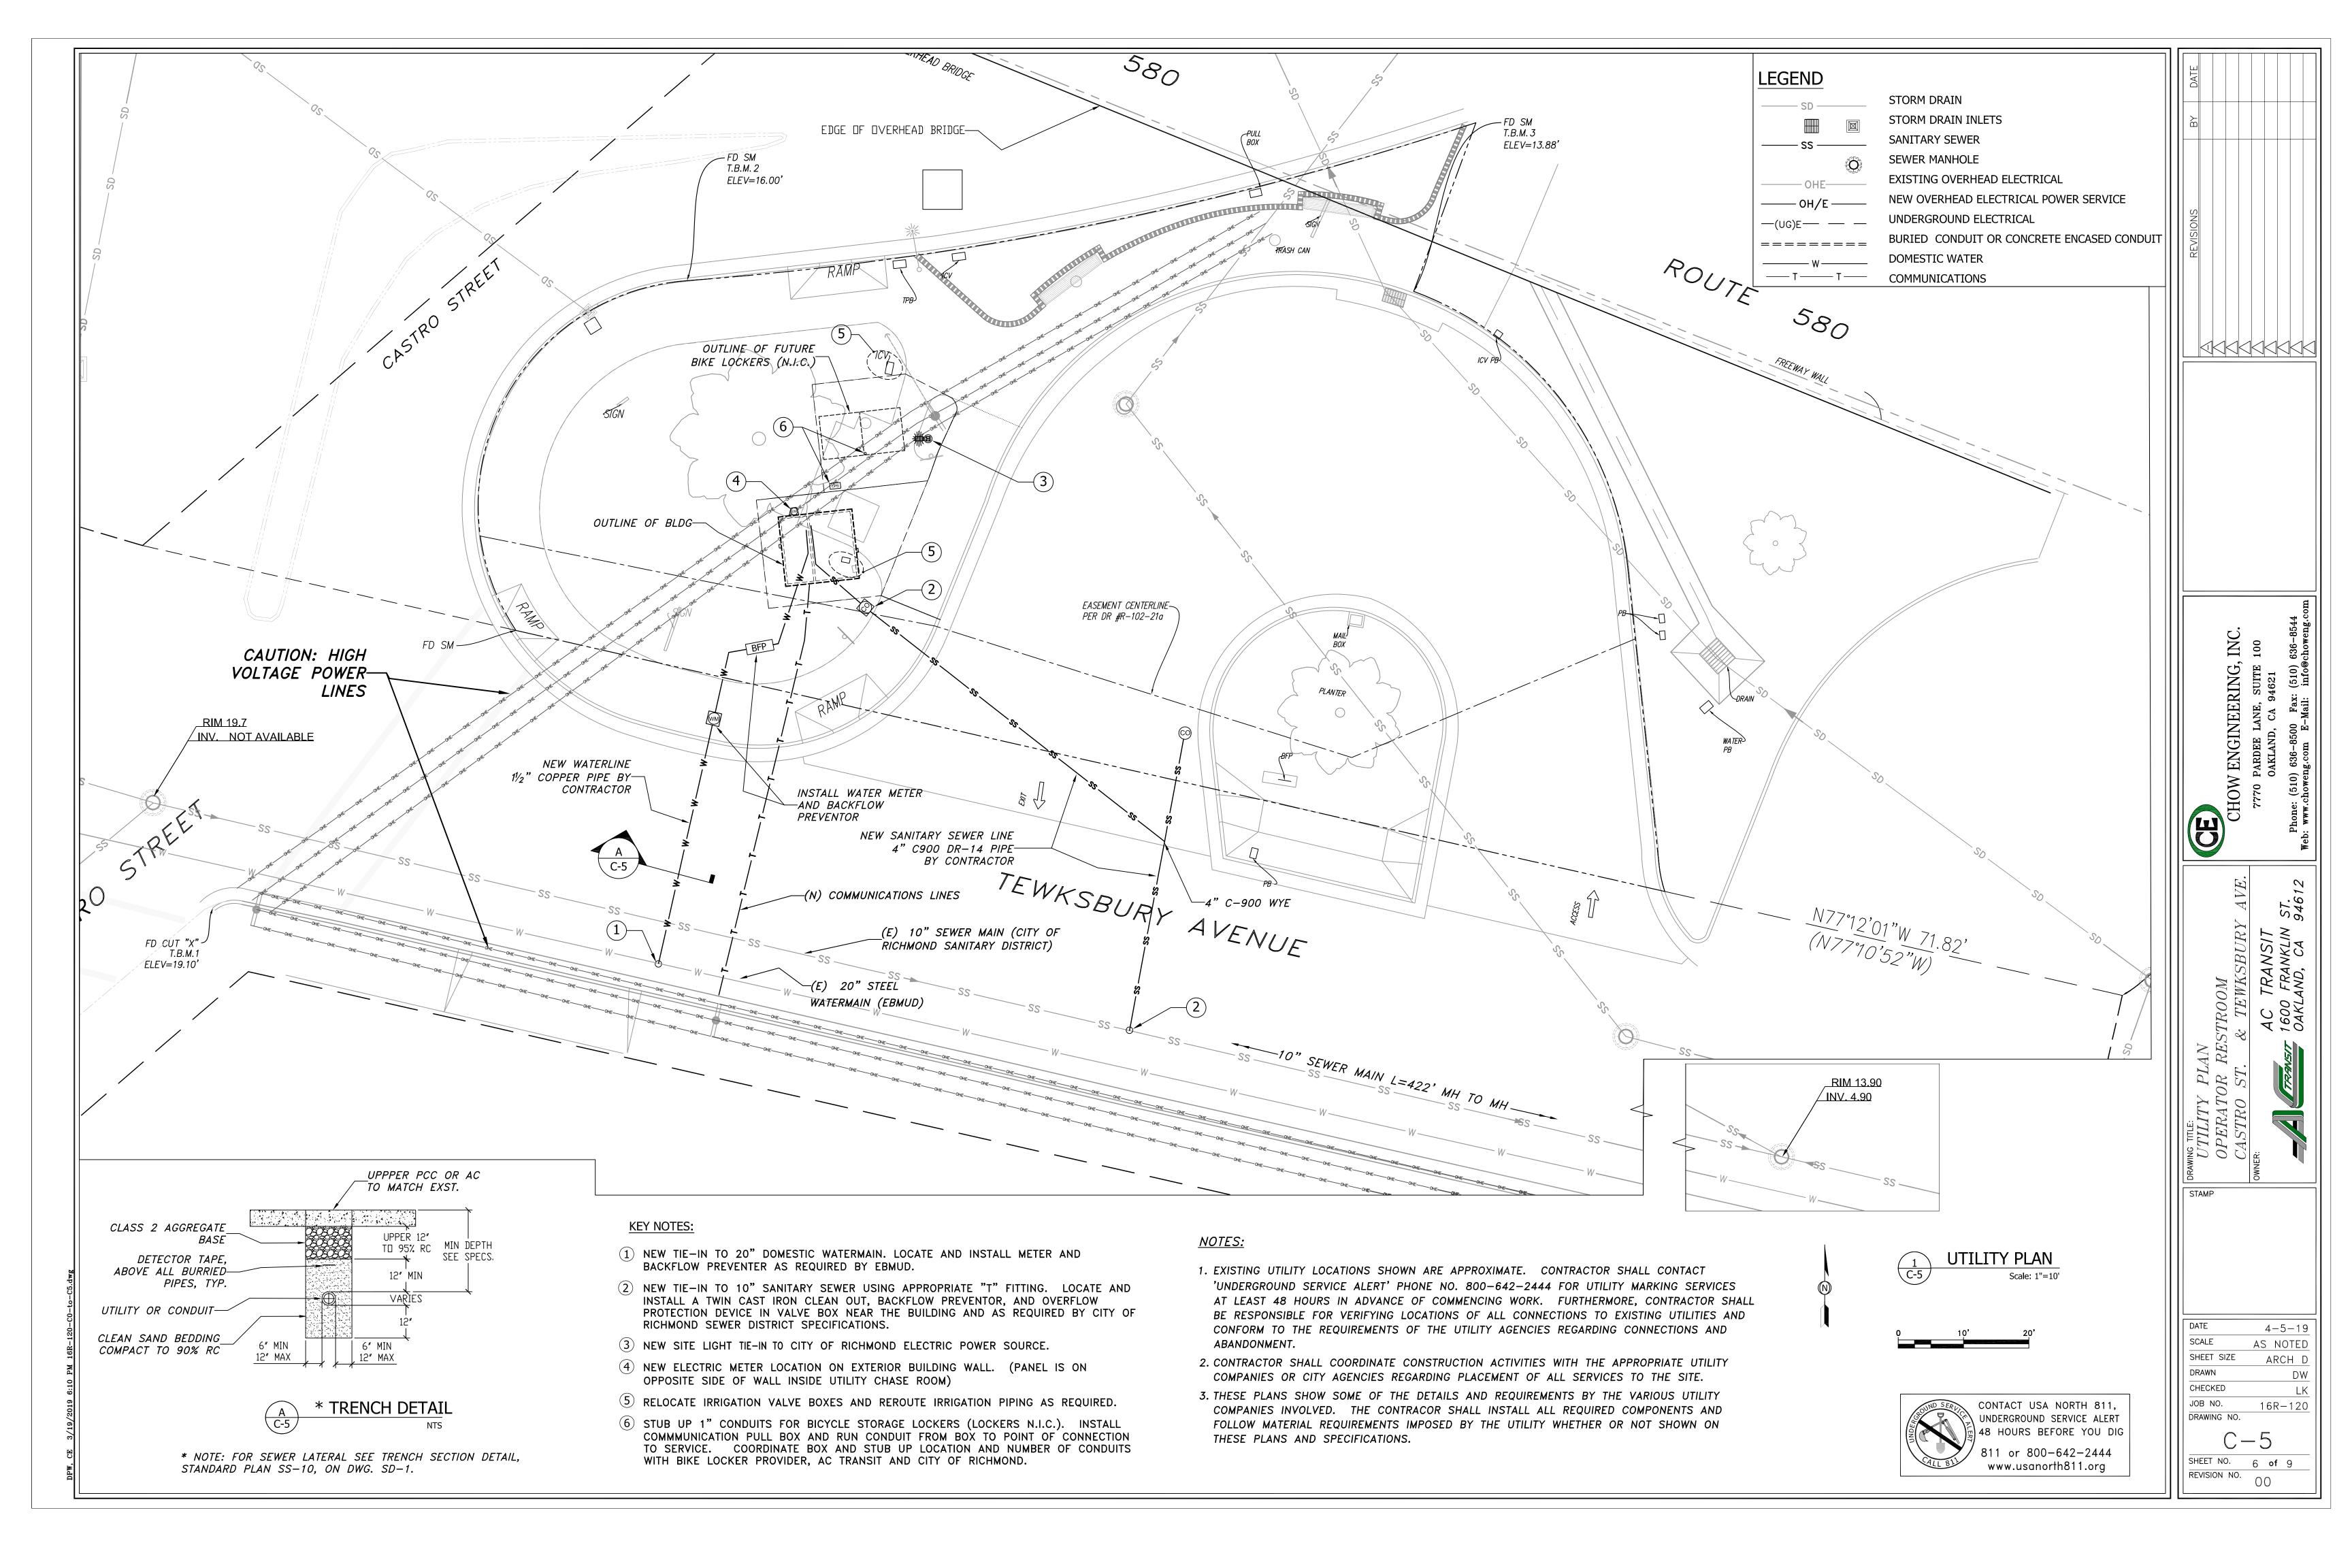

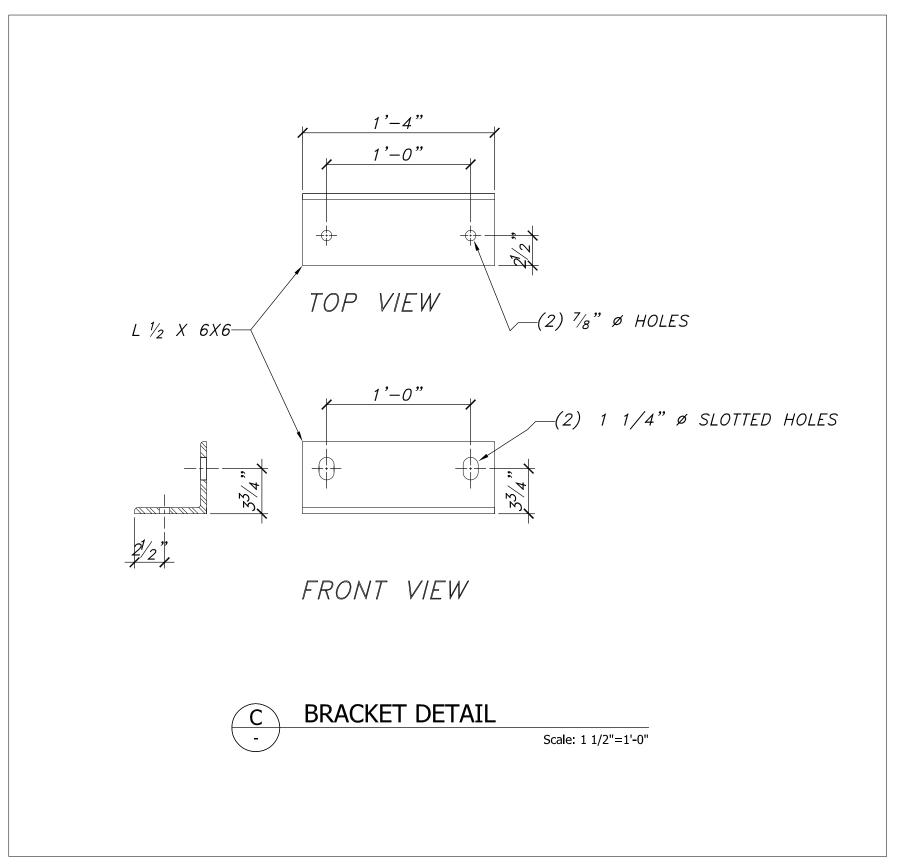

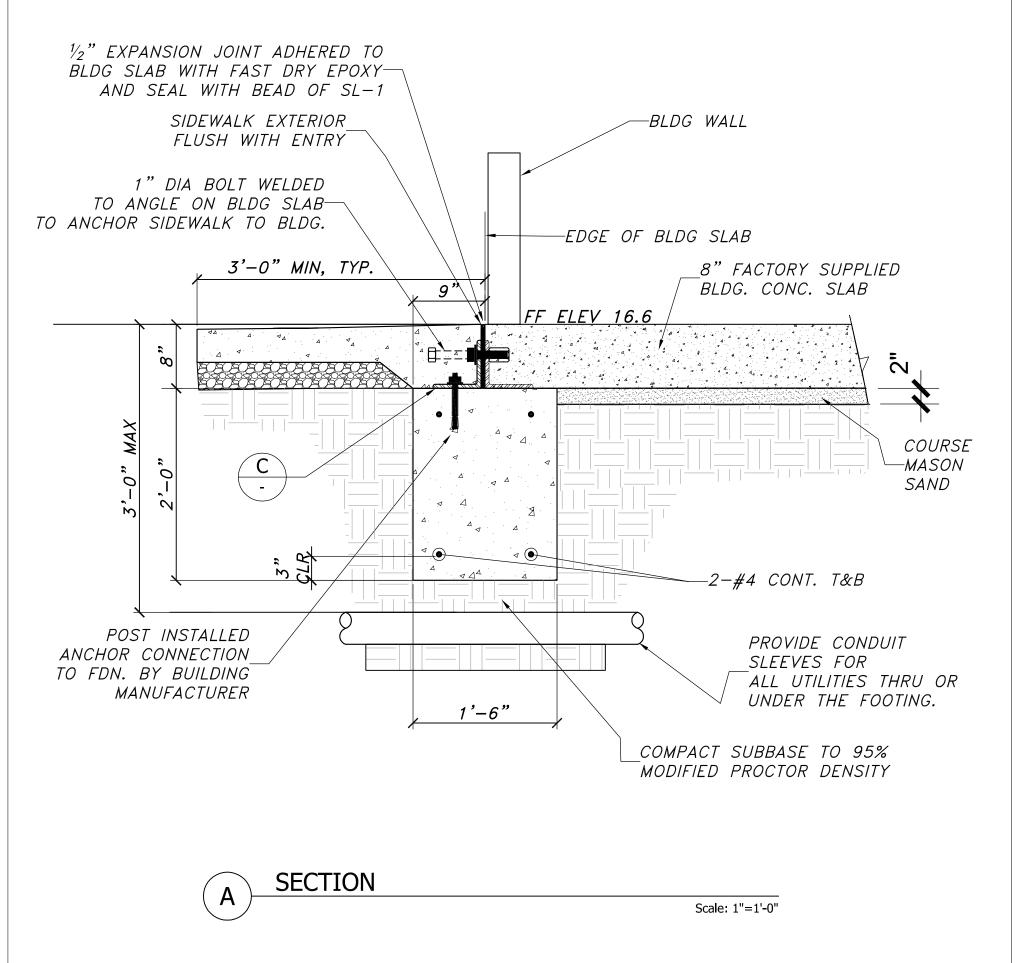

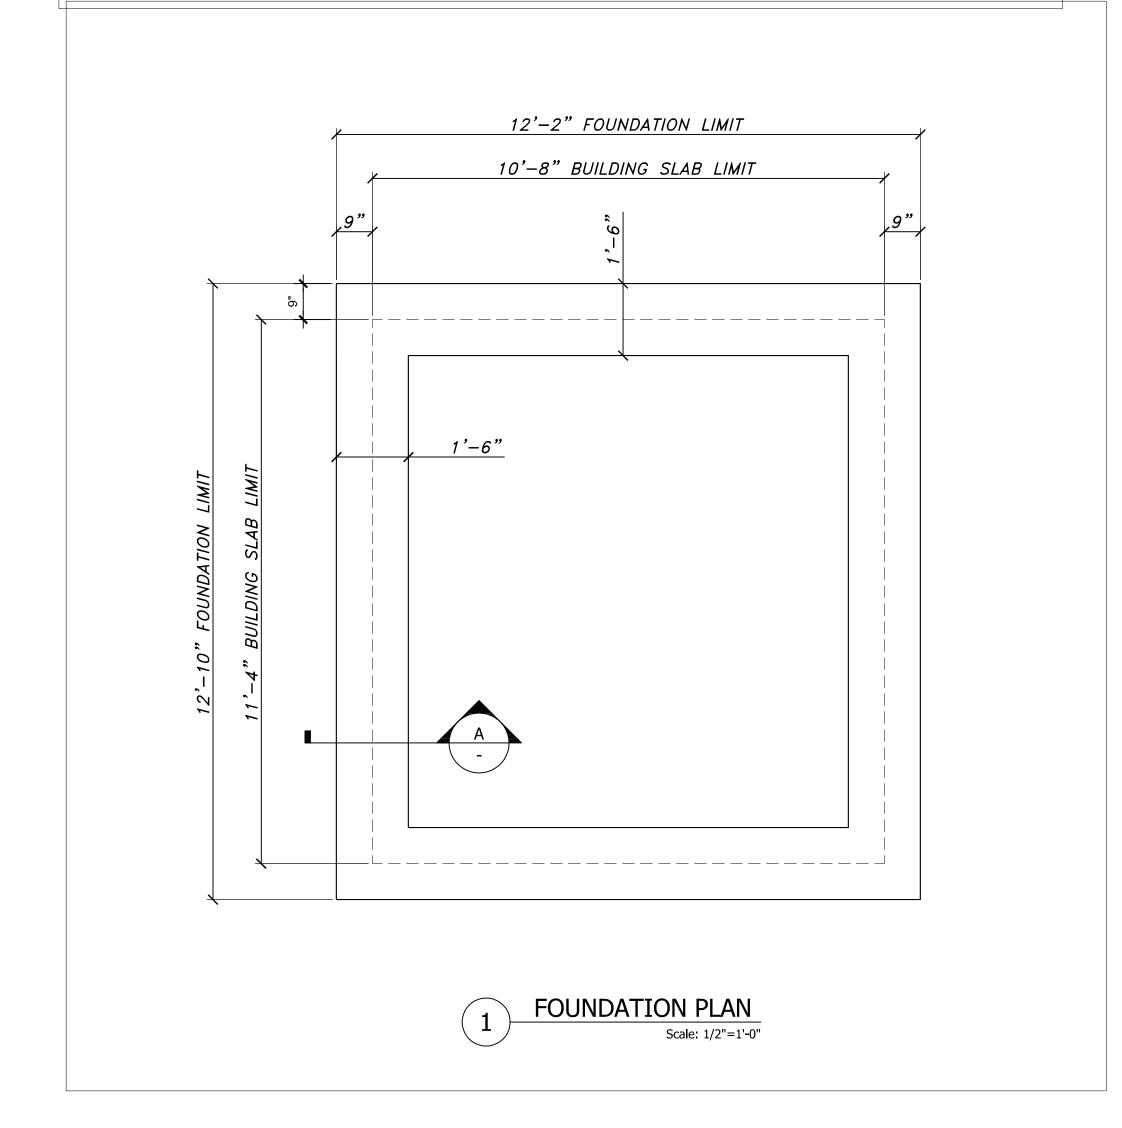

### **FOUNDATION NOTES:**

- 1. THE CONTRACTOR SHALL PREPARE THE BUILDING PAD PER DETAILS ON THIS SHEET. BOTTOM OF THE PRE-FAB SLAB BY THE PRE-FAB BUILDING MANUFACTKURER IS DEAD FLAT. TOP OF FOOTING AND COMPACTED BACK FILL MUST BE DEAD LEVEL. POUR FOOTING WITH LASER TRANSIT TO VERIFY TOP OF FOOTING.
- 2. THE MINIMUM ALLOWABLE SOIL BEARING PRESSURE REQUIRED IS 1500 PSF. THE SUBGADE TO BE COMPACTED TO 95% M.D.D.
- 3. THE CONTRACTOR SHALL SUPPLY AND STOCKPILE REQUIRED QUANTITY OF COARSE SAND WITHIN THE BUILDING PROXIMITY FOR USE AND PLACEMENT OF THE PREFABRICATED BUILDING. CONTRACTOR TO SET ELEVATION OF THE BASE. PAD ELEVATION MUST BE LEVEL WITHIN 2% AND COMPLY WITH ALL APPLICABLE CODES OF ACCESSIBILITY AND SAFETY. BEFORE BUILDING SET WET SAND FILL TO CONSOLIDATE AND /OR VIBRATE.
- 4. THE RESTROOM MANUFACTURER WILL FURNISH AND INSTALL UNDERGROUND UTILITIES UNDER THE BUILDING SLAB EXTENDING 6 FEET (MAX) BEYOND THE BUILDING LINE, MIN OF 24" — MAX OF 36" BELOW GRADE.
- 5. THE DIFFERENCE IN ELEVATION BETWEEN FINISH FLOOR OF THE RESTROOMS AND THE SIDEWALK OUTSIDE SHALL BE NO MORE THAN  $\frac{1}{4}$ ". SIDEWALK TO SLOPE AWAY FROM BUILDING AT A MINIMUM SLOPE OF 1%.
- 6. DETAILS REGARDING THE ROUTING AND PLACEMENT OF UTILITIES WITHIN AND TROUGH THE FOUNDATION WILL BE FULLY PRE-DETERMINED PRIOR TO THE POURING OF THE CONCRETE BASE SUPPORT STRUCTURE/ FOUNDATION.
- 7. FOUNDATION DIMENSIONS ASSUME THE SPECIFIC PREMANUFACTURED BUILDING BY PRC AS SHOWN ON THESE PLANS. APPROVED EQUAL BUILDING FOUNDATION DIMENSIONS MAY VARY GREATLY.

**BY** DPW 

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BLDG. FOUNDATIO


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DRAWING NO.

SHEET NO. 7 of 9 REVISION NO.



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		1		PL	LUIVIE	BING FIXTURE SCHEDULE	
		ROUGH-IN SERVICES					
ITEM	FIXTURE	COLD WATER	HOT WATER	WASTE	VENT	MANUFACTURER/MODEL	REMARKS
1	WATER CLOSET, FLOOR MOUNTED, ADA HEIGHT	1"	-	4"	2"	ACORN PENAL-WARE, 1975-W-1-HET-1-FVBO-ADA-PFS. FLOOR MOUNTED TOILET, REAR DISCHARGE, WITH CONCEALED ANTI-MICROBIAL LEVER FLUSH VALVES. TOILET SEAT BACK SHALL BE BLACK SOLID CORE PLASTIC, NON-FLAMMABLE CONSTRUCTION WITH CONTINUOUS SS CONCEALED SELF-CHECKING HINGES.	ADA
2	WATER CLOSET FLUSH VALVE					ZURN Z6143 AV-HET-BG-7L	
3	URINAL, ADA HEIGHT	3/4"	-	2"	2"	ACORN PENAL-WARE 1709HEU-W-1-0.125-FVBO	ADA
4	URINAL FLUSH VALVE					ZURN Z-6195AV-ULF-BG-7L	
5	LAVATORIES	1/2"	1/2"	1-1/2"	1 1/2"	ACORN PENAL-WARE 1652LRB-1-DMS-03-M, 18" SINK	ADA
7	SOAP DISPENSERS	-	-	-	-	VANDAL RESISTANT ASI #353 THROUGH THE WALL DISPENSOR WITH A BEHIND THE WALL SS TANK LOCATED INSIDE THE UTILITY CHASE FOR MAINTENANCE	
8	GRAB BARS	-	-	-	-	SS GRAB BARS, 1-1/4" MIN. EXPOSED FASTENER VANDAL RESISTANT DESIGN	ADA
9	TOILET PAPER HOLDER	-	-	-	-	COVERED THREE-ROLL, 18 GA STAINLESS STEEL, ATTACHED WITH 4 EPOXY BEDDED VANDAL RESISTANT SS SCREWS	
10	HAND DRYER	-	-	-	-	DYSON V-BLADE OR EQUAL	
11	QUICK CONNECT FITTING, 1/2"	-	1/2"	-	-	ON HOT WATER SERVICE PIPE - DORMONT	SOLIDLY WALL MOUNTED NEXT TO SINK

			PL	JMBI	NG E	QUIPMENT SCHEDULE	
		ROUGH-IN SERVICES					
ITEM	FIXTURE	COLD WATER	HOT WATER	WASTE	VENT	MANUFACTURER/MODEL	REMARKS
1	ELECTRIC WATER HEATER	1/2"	1/2"			STIEBEL DHC-E 8/10, TANKLESS	
2	WATER PRESSURE GAUGE/VALVE COMBO					COMMERCIAL GRADE INDUSTRIAL WATER PRESSURE GAUGE, ISOLATION BALL VALVE, 150 PSI PRESSURE REGULATOR WITH WYE STRAINER, CHECK VALVE AND KEYSTONE SR 40 240 WATER FILTER	
3	FLOOR DRAIN	-	-	-	-		
4	HOSE BIB - INTERIOR	1/2"	-	-	-		INSIDE UTILITY CHASE

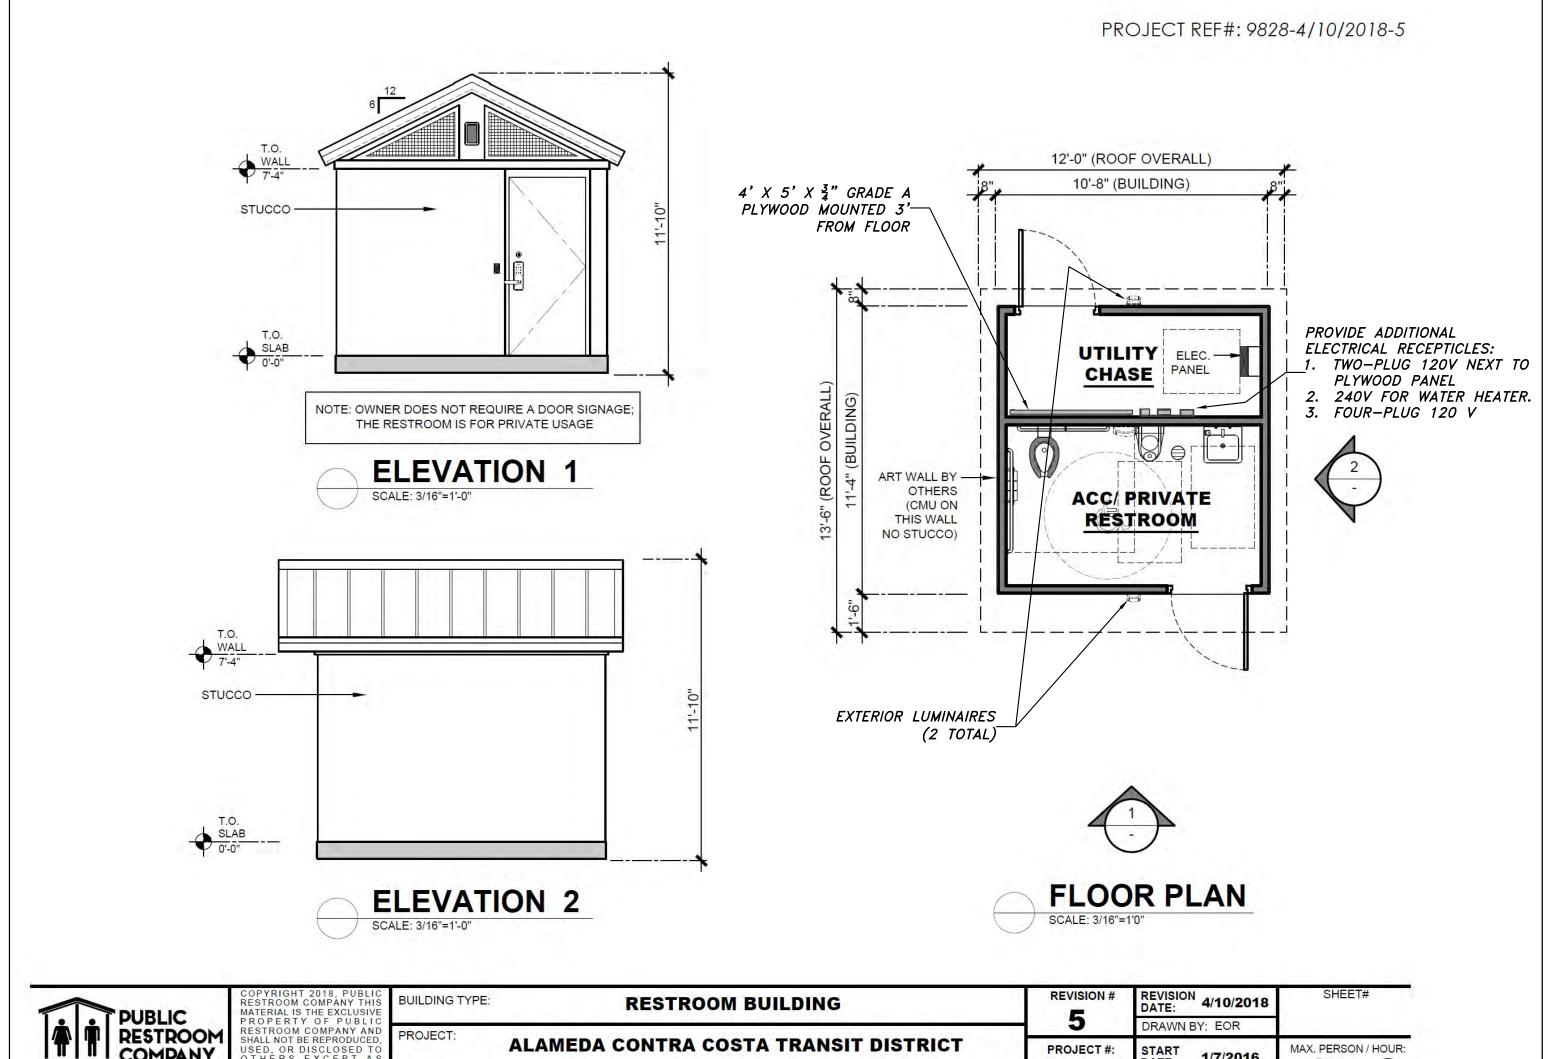			FINISH	SCHEDULE		
			WA			
AREA	FLOOR	EAST	WEST	NORTH	SOUTH	OTHER
EXTERIOR	CONCRETE, BROOM FINISH	FILLERS AND PAINTED	TH 2-4 MIL LAYERS OF 7- O WITH 2 LAYERS OF IND MIL THICKNESS. COLOF	USTRIAL HIGH SOLIDS,	NO STUCCO, SAME COLOR PAINT AS 3 OTHER WALLS	
GABLE ENDS		FIBER-CEMENT STUC PAINTED WITH INDUST PPG DOVER GRAY PP	TRIAL ENAMAL. COLOR:			
TRIM						COLOR: NAPOLEON PPG1013-7
ROOF						5/8" OSB SHEATHING, ICE/WATER SHIELD MEMBRANE, 26 GA STANDING SEAM METAL ROOF PANELS. COLOR RED: PPG1189-7
INTERIOR			LE GRAIN FINISH, 2-4 MIL DUSTRIAL HIGH SOLIDS			

ROOF			5/8" OSB SHEATHING, ICE/WATER SHIELD MEMBRANE, 26 GA STANDING SEAM METAL ROOF PANELS. COLOR RED: PPG1189-7	3.	HIN POV SPE FOR
INTERIOR	SMOOTHED TO PEBBLE GRAIN FINISH, 2-4 MII 2 LAYERS OF 4 MIL INDUSTRIAL HIGH SOLIDS				RES
		DOOR SCHEDULE			

COMPANY

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**ALAMEDA CONTRA COSTA TRANSIT DISTRICT** 

ALAMEDA, CA

1. THE RESTROOM MANUFACTURER WILL PROVIDE COMPLETE ARCHITECTURAL PLANS AND ENGINEERING CALCULATIONS, STAMPED BY CA REGISTERED DESIGN PROFESSIONALS FOR THE CONTRACTOR TO FILE FOR REQUIRED BUILDING PERMIT.

PROJECT #

9828

MAX. PERSON / HOUR:


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- 2. THE DOORS OF THE RESTROOM AND UTILITY CHASE ROOM SHALL BE "CARD-READER ACTIVATED" USING THE DISTRICTS MOST RECENT DOOR SECURITY SYSTEM PER THE AC TRANSIT IT DEPARTMENT. THE RESTROOM STRUCTURE AND THE TWO DOOR FRAMES SHALL BE FITTED WITH CONDUCTIVE HINGE, CONDUITS, WIRING, AND EQUIPMENT TO CONNECT TO A PANEL IN THE UTILITY CHASE FOR POWER AND CONNECTION TO THE AC TRANSIT COMMUNICATIONS SERVICE. REFER TO SPECIFICATIONS FOR ADDITIONAL INFORMATION.
- FOR ADDITIONAL INFORMATION ABOUT FURNISHING AND INSTALLING THE PRE-MANUFACTURED RESTROOM BUILDING, SEE SPECIFICATION SECTION 13-42-13.

		DOOR SCHEDULE	
YMBOL	SIZE	DESCRIPTION	REMARKS
1	3'-0" X 7'-0" h	LOCK SETS SHALL BE SCHLAGE MODEL 200 CO WITH CONDUCTIVE HINGE IN	CARD READER BOX SHALL BE PLACED NEXT TO DOORS, ADJACENT TO LOCK SETS. PROVIDE 1"-IN-WALL CONDUIT FROM EACH CARD READER BOX TO PLYWOOD PANEL IN UTILITY CHASE. A SECOND 1" CONDUIT SHALL BE PROVIDED FROM THE CONDUCTIVE HINGE TO THE WOOD PANEL IN THE UTILITY CHASE.

JOB NO. 16R-120 DRAWING NO. SHEET NO. 8 of 9


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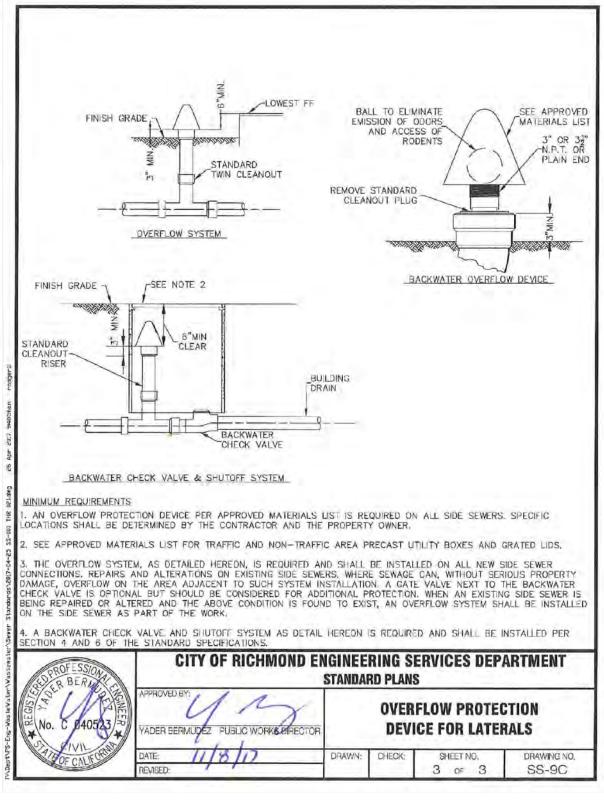



ADER BERMUDEZ PUBLIC WORKS DIRECT

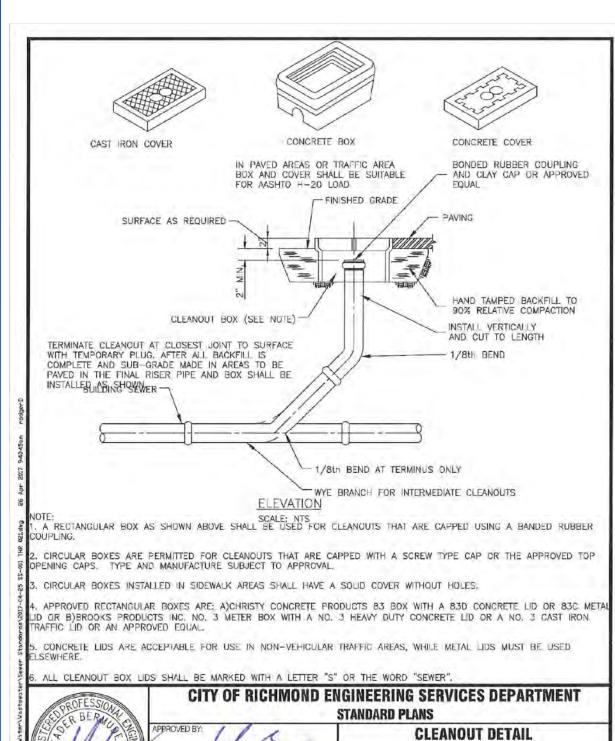
TO GRADE

WITH WYE CONNECTION




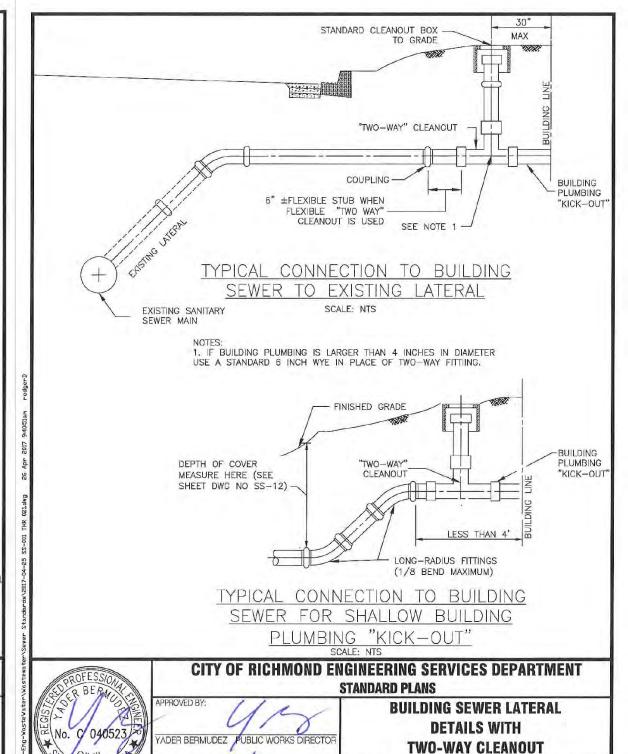

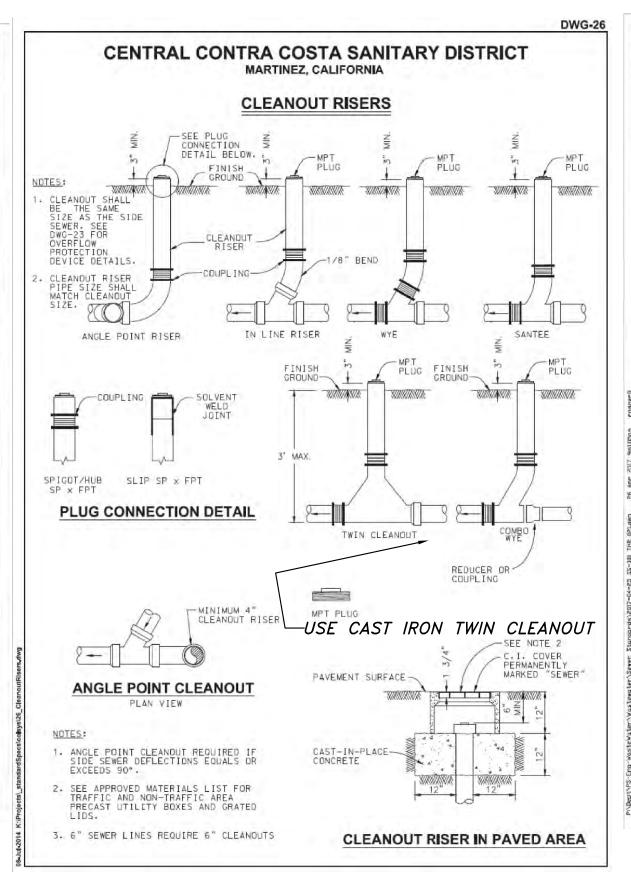


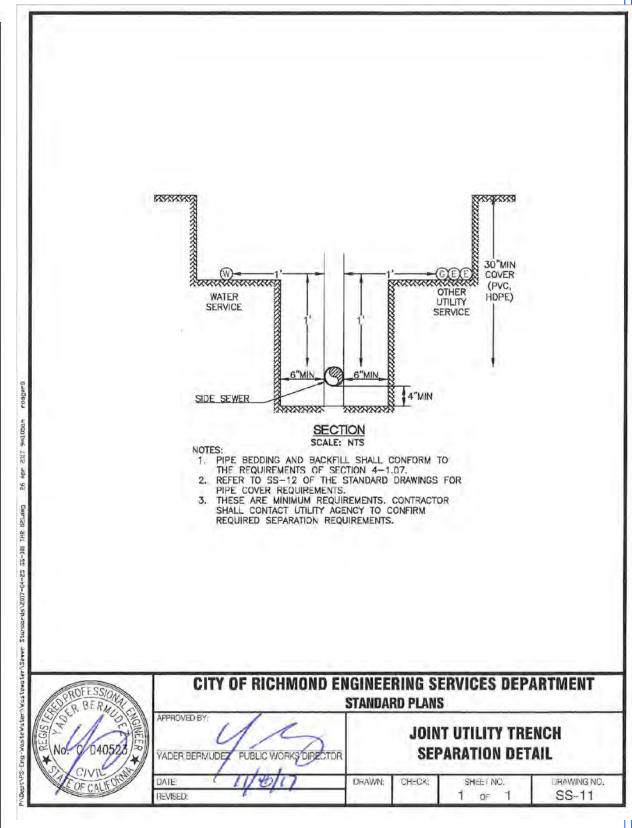




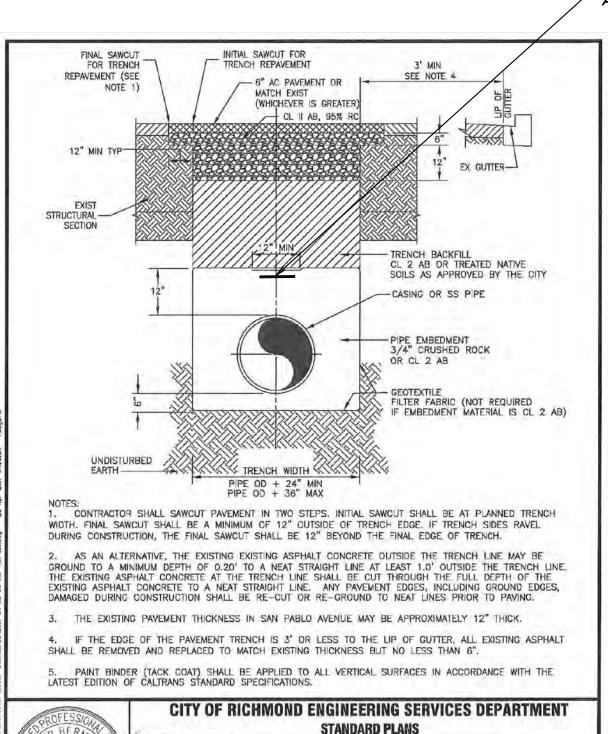



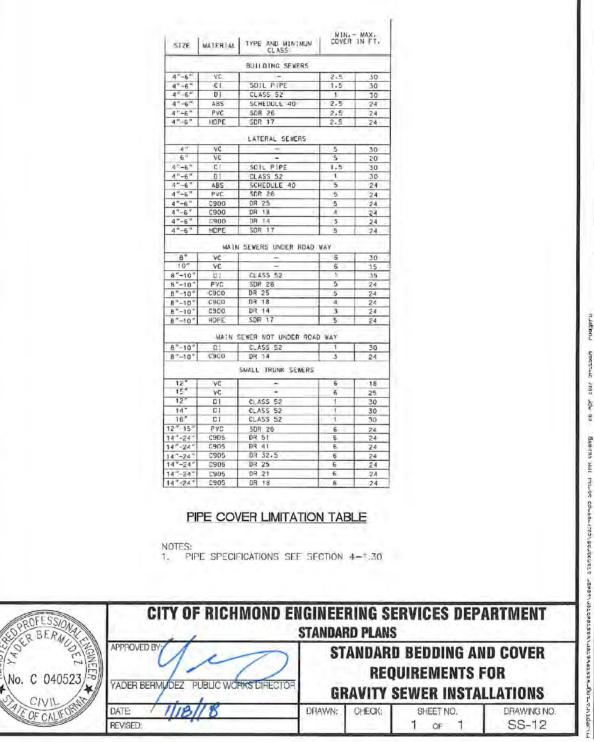

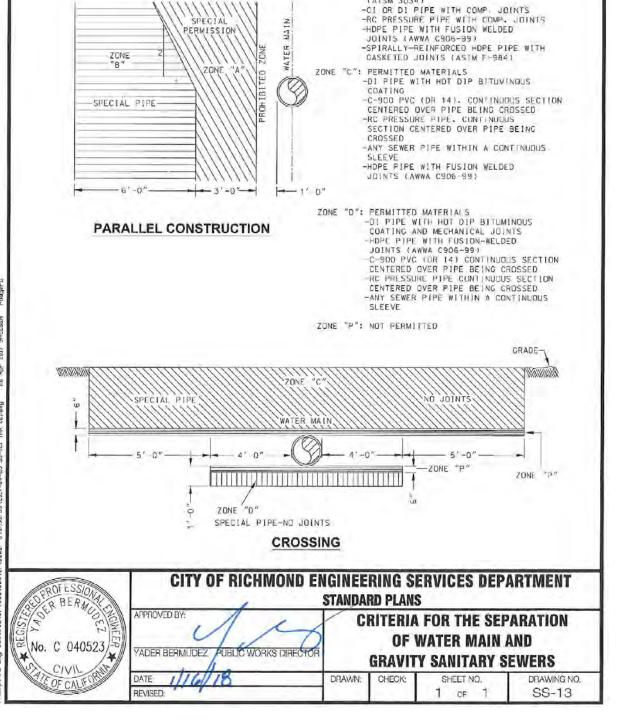


(REFERENCE: CALIFORNIA DOHS GUIDANCE

ZONE "A": SEWER LINES NOT PERMITTED

ZONE "B": PERMITTED MATERIALS


WITHOUT APPROVAL OF WATER AGENCY


-VC PIPE WITH COMPRESSION JOINTS -PVC PIPE WITH RUBBER RING JOINTS

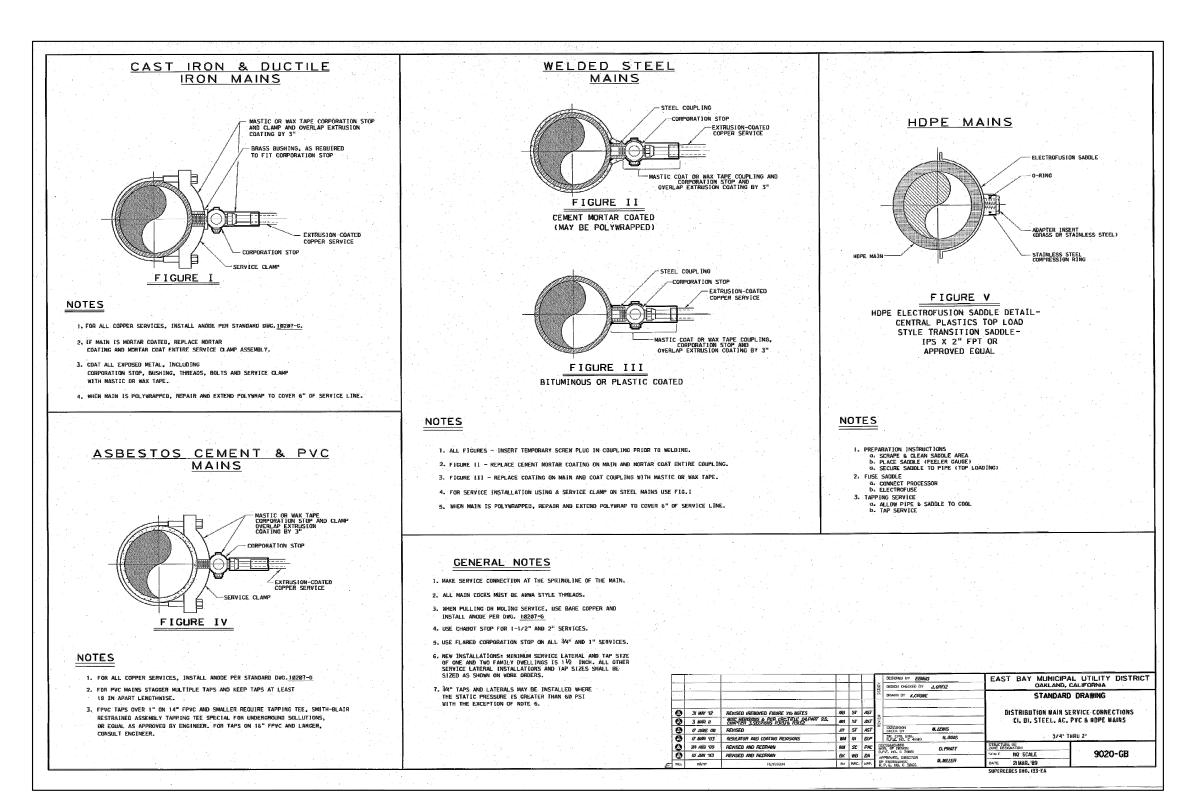

#### **SANITARY SEWER NOTES:**

- 1. COMPLY WITH ALL CITY OF RICHMOND'S SANITARY SEWER STANDARD SPECIFICATIONS FOR DESIGN AND CONSTRUCTION.
- 2. LATERAL SEWER LINE FROM BUILDING TO SEWER MAIN SHALL BE 4-IN C-900 DR18 PIPE WITH RING-TITE JOINTS, USE A NO HUB TWIN (WITHOUT BAFFLE) CAST IRON CLEANOUT. CONNECTIONS TO THE CLEANOUT SHALL BE MADE USING FERNCO SERIES 5000 ADAPTOR COUPLINGS WITH STAINLESS STEEL SHEAR BANDS AND
- ENGINEERING "A" CONTRACTOR LICENSED WITH THE CITY OF RICHMOND. TAPS TO NON-PVC MAINS ARE TO BE DONE BY THE TAP-TITE COMPANY OR ROTOR ROOTER. THE USE OF TAPS SHALL BE PRE-APPROVED IN WRITING FROM THE CITY OF RICHMOND PRIOR TO THE TAP. THE CONTRACTOR SHALL BE RESPONSIBLE FOR OBTAINING TAP PERMISSION.

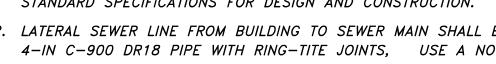

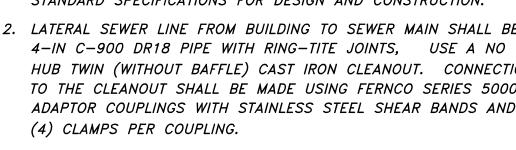

3. ONLY TAPS TO A PVC SEWER MAIN MAY BE DONE BY GENERAL

4-5-19 SCALE AS NOTED ARCH D 16R-120

STAMP

SHEET SIZE DRAWN CHECKED JOB NO. DRAWING NO.

SHEET NO. 9 of 9 REVISION NO.